INDEX OF SHEETS

SHEET NO. 1-2 TITLE & GENERAL NOTES


SHEET NO. C801R-C802R LANDSCAPE PLAN

SHEET NO. C20IR-C202R REMOVALS
SHEET NO. C40IR-C402R STREET RESTORATION
SHEET NO. C50IR-C502R GRADING & TYPICAL SECTION
SHEET NO. C60IR-C602R UTILITIES
SHEET NO. C70IR-C702R SITE DETAILS

615 W. JOHNSON STREET - WITTE HALL

WORK TO BE COMPLETED UNDER
PERMIT TO EXCAVATE IN THE RIGHT-OF-WAY

PROJECT LOCATION

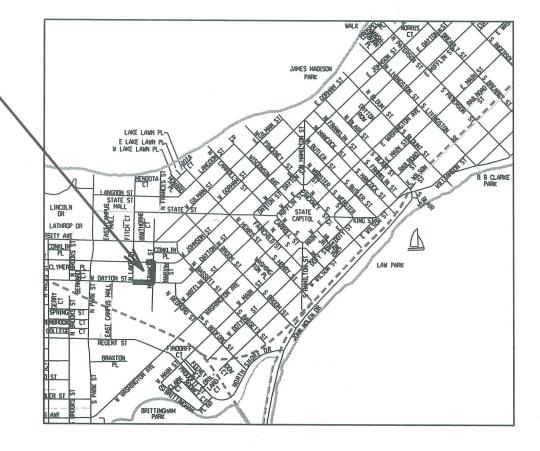

PUBLIC IMPROVEMENT DESIGN

City Engineer 7

RIGHT-OF-WAY IMPROVEMENTS DESIGNED BY:

> SEE SHEETS

W N

REV. DATE:

- MADISON, STREETS DIVISION

SINATOR: CITY OF MADISON, STR

CONVENTIONAL SIGNS
FIELD VERIFY ALL UTILITY LOCATIONS

STORM SEWER SANITARY SEWER

OVERHEAD ELECTRIC
BURIED ELECTRIC
LIGHT POLE

ANY PAVEMENT MARKINGS THAT ARE REMOVED OR DAMAGED SHALL BE REPLACED BY THE DEVELOPER/CONTRACTOR AS DIRECTED BY CITY TRAFFIC ENGINEERING.

THE LOCATION AND INFORMATION FOR PROPOSED NEW TREES, IN THE PUBLIC RIGHT OF WAY OR ON PUBLIC LANDS ARE APPROXIMATE AND ARE SHOWN FOR REFERENCE ONLY. COORDINATE WITH CITY FORESTRY FOR LOCATION OF ANY NEW TREE GRATES; SOME EXCAVATION MAY BE NECESSARY WHEN PLACING NEW GRATES TO VERIFY THAT THE SITE IS APPROPRIATE FOR TREE PLANTING.

CONTRACTOR SHALL CONTACT DEAN KAHL WITH CITY FORESTRY (266–4891 OR 266–4816) AT LEAST ONE WEEK PRIOR TO PLANTING TO ALLOW FORESTRY TO MARK THE PLANTING SITES AND REVIEW PLANTING SPECIFICATIONS WITH THE LANDSCAPING CONTRACTOR. TREE PLANTING WITHIN THE PUBLIC RIGHT OF WAY OR ON PUBLIC LANDS SHALL BE APPROVED BY THE CITY FORESTER PRIOR TO INSTALLATION.

NO TREES IN THE RIGHT OF WAY OR ON PUBLIC LANDS SHALL BE TRIMMED, PRUNED, REMOVED OR ADVERSELY AFFECTED IN ANY WAY UNTIL THE DEVELOPER HAS RECEIVED WRITTEN PERMISSION FROM THE CITY ENGINEER OR CITY FORESTER. SAID WRITTEN PERMISSION SHALL INCLUDE LANGUAGE INDICATING THAT SECTION 10.101 OF THE MADISON GENERAL ORDINANCES AND ADMINISTRATIVE PROCEDURE MEMORANDUM NO. 6–2, REFERING TO NOTIFICATION OF PROPERTY OCCUPANTS AND/OR OWNERS, HAS BEEN COMPLIED WITH.

COORDINATE WITH CITY ENGINEERING A MINIMUM OF 21 DAYS IN ADVANCE FOR INSTALLATION OF ASPHALT PAVEMENT FOLLOWING CONSTRUCTION OF NEW CURB $\ensuremath{\mathfrak{S}}$ GUTTER AND BASE COURSE.

TRAFFIC CONTROL REQUIREMENTS RELATED TO THIS PROJECT:

SUBMIT A TRAFFIC CONTROL PLAN TO CITY TRAFFIC ENGINEERING AT LEAST 14 DAYS PRIOR TO THE START OF WORK. WORK SHALL NOT PROCEED UNTIL AN APPROVED TRAFFIC CONTROL PLAN IS IN PLACE.

MAINTAIN TWO-WAY TRAVEL ON ALL STREETS AT ALL TIMES.

PROVIDE APPROPRIATE SIGNAGE, INCLUDING FOR ANY BIKE LANE CLOSURES OR DETOURS AS REQUIRED BY THE APPROVED TRAFFIC CONTROL PLAN

MAINTAIN SIDEWALK ACCESS ON AT LEAST ONE SIDE OF ALL STREETS AT ALL TIMES. PROVIDE ADVANCED WARNING OF ANY SIDEWALK CLOSURES AT PRIOR CROSSINGS. ALL PAVEMENT WITHIN THE RIGHT-OF-WAY SHALL BE TYPE C PAVEMENT.

ALL GUTTERS SHALL DRAIN WITH A MINIMUM GRADES OF 0.5% TOWARD STORM SEWER INLETS.

THE CROSS SLOPE OF SIDEWALKS AND BARRIER FREE SIDEWALK CURB
RAMPS SHALL BE 1.5%. THE LONGITUDINAL GRADE OF BARRIER
FREE SIDEWALK CURB RAMPS SHALL NOT EXCEED 8.33%. ALL SIDEWALK
RAMPS SHALL BE CONSTRUCTED ACCORDING TO S.D.D. 3.03. AT ALL
OTHER LOCATIONS THE LONGITUDINAL GRADE OF SIDEWALKS SHALL
NOT EXCEED 5.0 % OR THE ADJACENT STREET GRADE WHICHEVER
IS GREATER NOR BE LESS THAN 0.4% AND SHALL DRAIN TOWARD
STORM SEWER INLETS. SIDE SLOPES WITHIN TEN FEET OF A PUBLIC
SIDEWALK SHALL NOT EXCEED 4.00:1. ALL SIDEWALK AND SIDEWALK RAMP
ELEVATIONS AND GRADES SHALL BE FIELD VERIFIED AND SET TO COMPLY WITH
THE CITY OF MADISON STANDARD SPECIFICATIONS AND THE A.D.A. GUIDELINES.

POWER POLES AND OTHER OBSTRUCTIONS SHALL BE MOVED TO PROVIDE 2 FEET MINIMUM OF CLEAR DISTANCE FROM ANY FACE OF CURB OR EDGE OF SIDEWALK.

THERE MAY BE EXISTING UTILITIES OR OTHER FEATURES WHICH ARE EITHER NOT SHOWN OR SHOWN INCORRECTLY ON THIS PLAN. IT IS THE RESPONSIBILITY OF THE DEVELOPER TO LOCATE AND IDENTIFY ALL UTILITIES AND TOPOGRAPHY WHICH MAY AFFECT THE CONSTRUCTION OF THESE IMPROVEMENTS.

ALL PERMANENT SIGNING AND POSTING WILL BE DETERMINED AND PROVIDED BY THE TRAFFIC ENGINEERING DIVISION, FOLLOWING CONSTRUCTION OF THESE IMPROVEMENTS.

THE DEVELOPER SHALL PROVIDE, INSTALL AND MAINTAIN ALL STREET END BARRICADES, SIGNING AND TRAFFIC CONTROL, AS REQUIRED BY THE CITY TRAFFIC ENGINEER.

PAVEMENT SAWCUTS SHALL BE AS DIRECTED BY THE CITY CONSTRUCTION ENGINEER. SAWCUTS SHOWN ON THE PLAN ARE APPROXIMATE

DAMAGE TO ANY EXISTING CURB, PAVEMENT, SIDEWALK, ETC. THAT IS TO REMAIN SHALL BE REPAIRED BY THE DEVELOPER/CONTRACTOR AS DIRECTED BY THE ENGINEER.

DEVELOPER/CONTRACTOR SHALL COORDINATE WITH ALL UTILITY COMPANIES TO ADJUST STRUCTURES, MANHOLES, HANDHOLES, ETC. AS NEEDED TO MATCH THE GRADE OF THE NEW PAVEMENT.

615 W. JOHNSON ST - WITTE HALL PROJECT NO. 11669 SHEET NO.

DETAIL


STANDARD NOTES AND COMMENTS

CITY OF MADISON

FILE NAME:

M:\DESIGN\Projects\11669\11669EN-GenINote_D1.dgn

DATE: 7/17/2017

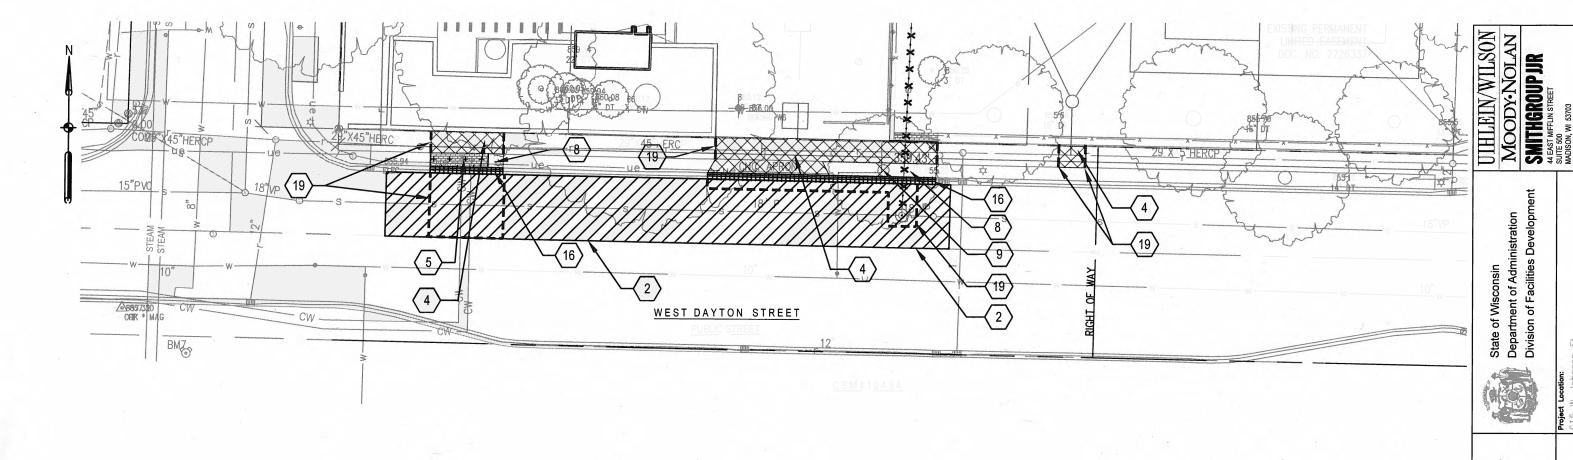

SITE PREPARATION LEGEND

WHITCONS/N

DAVID K.

WOLMUTT

E-31264


ASPHALT DRIVE 2" MILL AND OVERLAY CONCRETE SIDEWALK AND BASE REMOVAL $\left(5\right)$ **BRICK PAVER REMOVAL** $\left(\begin{array}{c} 6 \end{array} \right)$ GRAVEL REMOVAL 8 **CLEARING AND GRUBBING** 9 TREE REMOVAL TREE PROTECTION FENCE (14) x · x · x · x · x · UTILITY REMOVAL $\langle 16 \rangle$ $\langle 19 \rangle$ SAWCUT SIDEWALK / ASPHALT PAVEMENT -TYPE III TRENCH PATCHES AT UTILITY TRENCH WORK WITHIN THE STREET.


SITE PREPARATION NOTES

- CONTRACTOR SHALL PROTECT ALL UTILITIES AND SITE FEATURES UNLESS OTHERWISE SHOWN TO BE REMOVED OR ABANDONED.
- ALL SITE EROSION CONTROL MEASURES SHALL BE MAINTAINED BY CONTRACTOR AND SHALL BE REPAIRED OR REPLACED AS NEEDED TO SERVE INTENDED FUNCTION.
- SUBMIT DOCUMENTATION SHOWING MEANS AND METHODS OF DUST CONTROL AS PERFORMED THROUGHOUT THE JOB. DOCUMENTATION SHOULD INCLUDE SITE REPORTS (WEEKLY) DESCRIBING WORK PERFORMED AND MEANS IMPLEMENTED AND SHALL BE ACCOMPANIED BY SUPPORTING PHOTOS.
- CONTRACTOR IS RESPONSIBLE FOR REMOVAL OF ALL CONSTRUCTION FENCING AND EROSION CONTROL MEASURES AT PROJECT COMPLETION UNLESS OTHERWISE NOTED.
- CONTRACTOR SHALL CLEAN ROAD SURFACES THROUGHOUT THE DAY TO PREVENT TRACKING OF MATERIALS OFF SITE.
- ALL SAWCUTS SHALL BE TO THE NEAREST JOINT AND SHALL BE FULL DEPTH CUTS.
- CONTRACTOR SHALL INSTALL TREE PROTECTION FENCING IN THE AREA BETWEEN THE CURB AND SIDEWALK AND EXTEND IT AT LEAST 5 FEET FROM BOTH SIDES OF THE TREE ALONG THE LENGTH OF THE TERRACE. NO EXCAVATION IS PERMITTED WITHIN 5 FEET OF THE OUTSIDE EDGE OF A TREE TRUNK. IF EXCAVATION WITHIN 5 FEET OF ANY TREE IS NECESSARY, CONTRACTOR SHALL CONTACT CITY FORESTRY (266-4816) PRIOR TO EXCAVATION TO ASSESS THE IMPACT TO THE TREE AND ROOT SYSTEM. TREE PRUNING SHALL BE COORDINATED WITH CITY FORESTRY. TREE PROTECTION SPECIFICATIONS CAN BE FOUND IN SECTION 107.13 OF CITY OF MADISON STANDARD SPECIFICATIONS FOR PUBLIC WORKS CONSTRUCTION. ANY TREE REMOVALS THAT ARE REQUIRED FOR CONSTRUCTION AFTER THE DEVELOPMENT PLAN IS APPROVED WILL REQUIRE AT LEAST A 72-HOUR WAIT PERIOD BEFORE A TREE REMOVAL PERMIT CAN BE ISSUED BY FORESTRY. TO NOTIFY THE ALDER OF THE CHANGE IN TREE PLAN.
- SITE WORK MAY BE REQUIRED WITHIN CERTAIN TREE PROTECTION ZONES. WHEN SUCH WORK IS REQUIRED THE TREE PROTECTION FENCE SHALL BE ADJUSTED AS REQUIRED TO COMPLETE THE WORK, MINIMIZING IMPACT ON THE TREE ZONE. TREE PROTECTION ZONE SHALL BE REESTABLISHED IMMEDIATELY AFTER REQUIRED WORK HAS BEEN COMPLETED.
- CLEARING AND GRUBBING SHALL NOT TAKE PLACE WITHIN TREE PROTECTION AREAS. TURF REMOVAL ONLY. REMOVE SOD CAREFULLY BY HAND. PROTECT TREE ROOTS. TEST AND LIGHTLY AMEND SOILS AS NEEDED AND RESTORE AREA WITH MULCH RING AND TURF.

- Madison Wisconsin RENOVATION of Wiscons Wisconsin University
Madison, V WITTE Revisions

Graphic Scale DFD Numbe Set Type Date Issued 7/07/2017 C201R

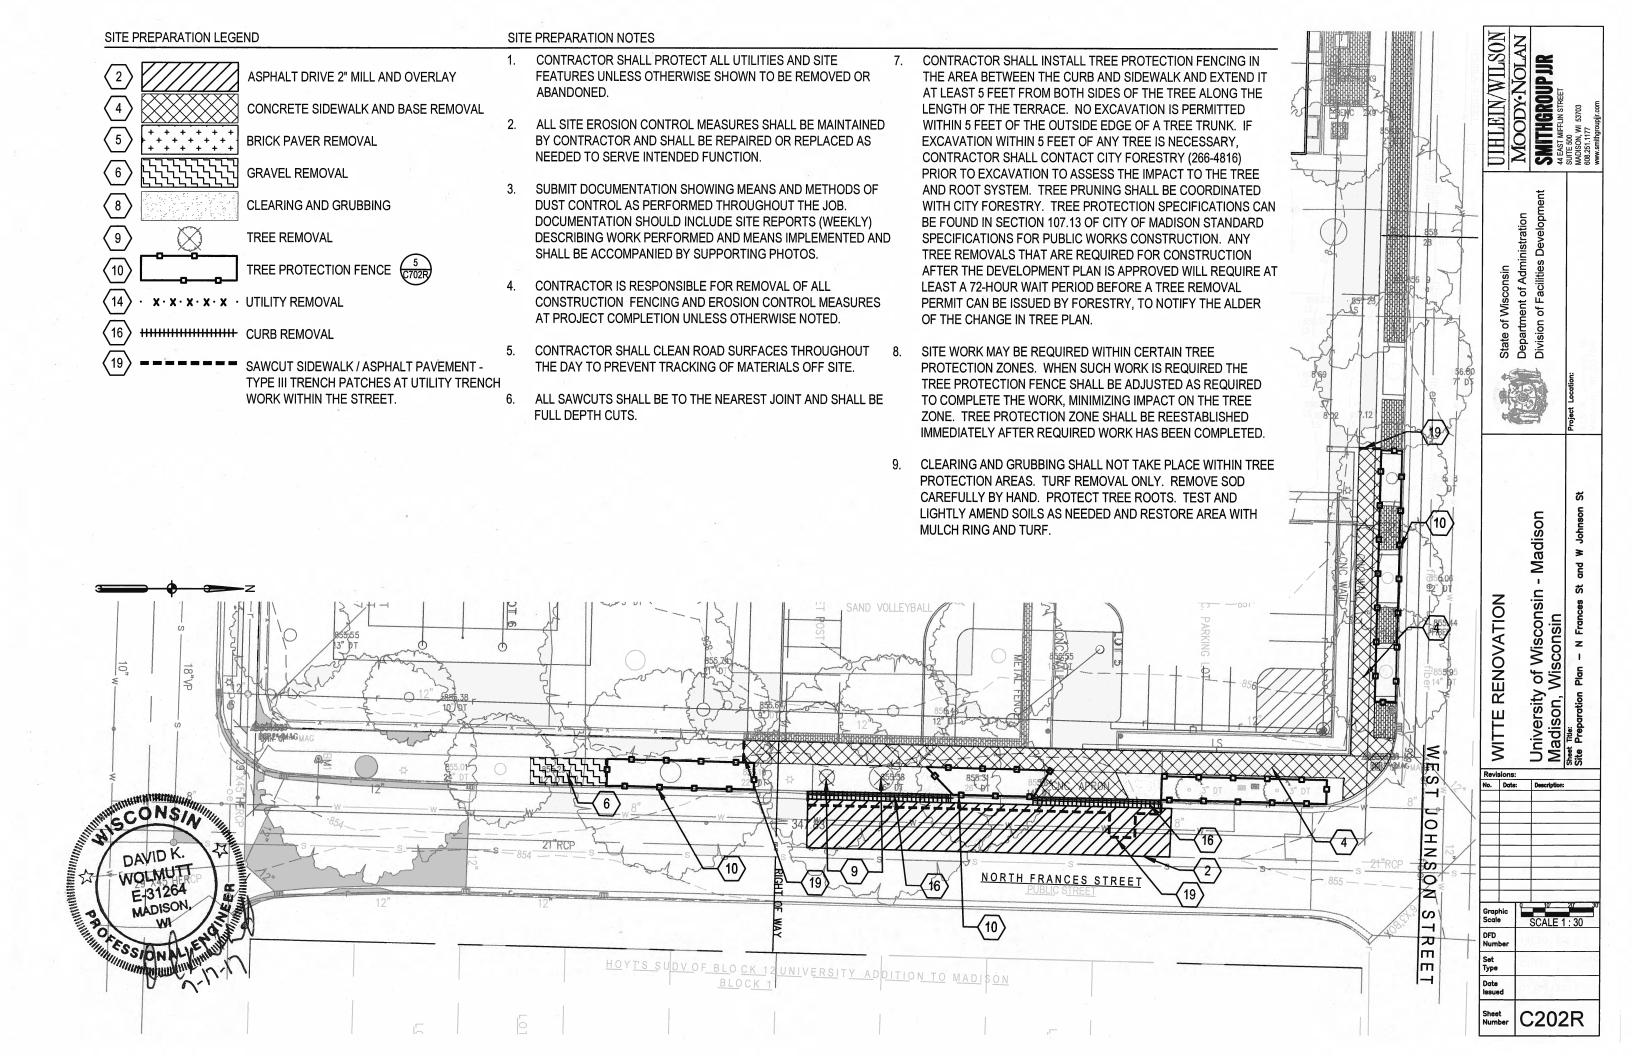

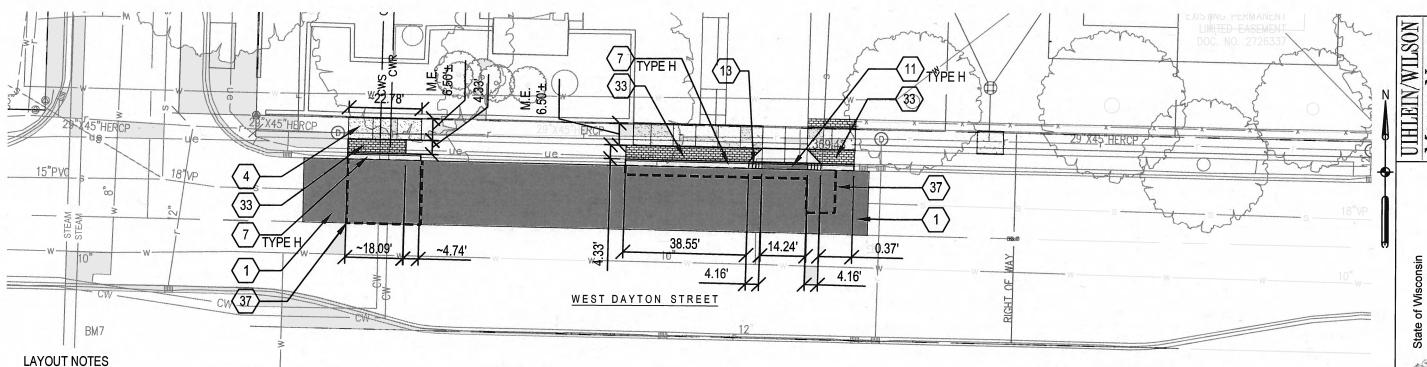


- CURB DIMENSIONS ARE TO BACK OF CURB, UNLESS OTHERWISE NOTED.
- 2. ALL DIMENSIONS MUST BE FIELD VERIFIED AND ANY DISCREPANCIES REPORTED TO THE OWNER'S REPRESENTATIVE IMMEDIATELY.
- 3. ADJUST LAYOUT AS DIRECTED BY THE ARCHITECT TO ENSURE PROPER CONNECTION TO EXISTING FACILITIES AND SITE AMENITIES.
- PROPOSED CURBS TO BE FIELD STAKED FOR APPROVAL OF THE LANDSCAPE ARCHITECT PRIOR TO INSTALLATION.
- 5. WHERE PROPOSED DRIVE/SIDEWALK ABUTS EXISTING DRIVE/SIDEWALK, JOINT PATTERNS SHALL MATCH AND SUPERCEDE JOINT PATTERNS SHOWN ON PLANS.
- 6. SET AUXILIARY BENCHMARKS AS REQUIRED TO LAYOUT AND CONSTRUCT WORK.
- 7. PAVING RADII SHALL BE FORMED COMPLETELY AND SMOOTHLY TRANSITION INTO TANGENTS AND ADJOINING LINES. FLAT CURVE SEGMENTS IN HORIZONTAL LAYOUT SHALL BE REMOVED AND REPLACED AT NO COST TO OWNER.

MATERIALS NOTES

- SEE EXISTING CONDITIONS PLAN C101 FOR LEGEND OF EXISTING FEATURES, PROJECT BENCHMARKS, VERTICAL AND HORIZONTAL CONTROL POINTS.
- 2. HATCH PATTERNS ARE FOR REFERENCE ONLY. HATCHES DO NOT REPRESENT DIRECTIONAL LAYOUT OR PATTERN OF MATERIALS.
- SEE SHEET C501R & C502R FOR GRADING
- 4. SEE SHEET C801R & C802R FOR PLANTING PLAN.

- 8. ALL WORK WITHIN THE RIGHT OF WAY SHALL CONFORM TO CITY OF MADISON STANDARDS AND GENERAL ORDINANCES.
 - 8.1. ALL SIDEWALK, INCLUDING EXPANSION JOINT PLACEMENT AND MATERIALS, SHALL BE PER CITY STANDARDS.
 - 8.2. ANY FULL DEPTH PAVEMENT REPLACEMENT SHALL BE CITY OF MADISON TYPE C PAVEMENT. 5.25" HMA TYPE E-3, 4" GRADATION NO.2, 6" GRADATION NO. 1
 - 8.3. N. FRANCES STREET CURB SHALL BE CITY OF MADISON STANDARD TYPE "A"
 - 8.4. W. DAYTON STREET CURB SHALL BE CITY OF MADISON STANDARD TYPE "H"
 - 8.5. DETAILS CAN BE FOUND AT http://www.cityofmadison.com/business/pw/documents/ StdSpecs/2017/Part8.pdf
- PAVEMENT PATCHING IN THE RIGHT OF WAY SHALL BE PER CITY'S PATCHING CRITERIA: ANY PATCHES WITHIN 100 FT. OF EACH OTHER SHALL BE COMBINED INTO A SINGLE LARGER PATCH. PATCHES ARE A MINIMUM OF 2" MILL AND OVERLAY.
- VEHICULAR AND BIKE PARKING FACILITIES ARE DESIGNED TO MEET THE UNIVERSITY OF WISCONSIN-MADISON AND STATE OF WISCONSIN REQUIREMENTS.

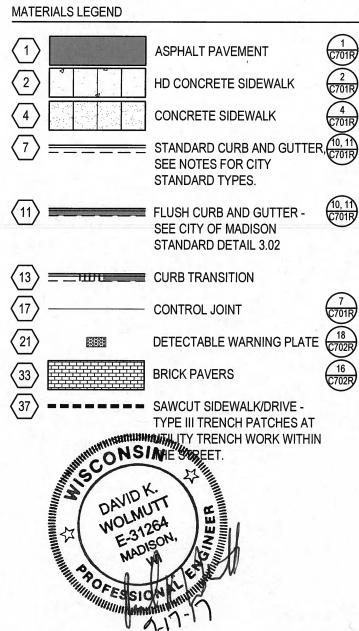

SMITHGROUP JJR

Department of Administration Division of Facilities Developi

Madison

Wisconsin

o

SCALE 1 : 30

7/07/2017

C401R

Wisconsin


RENOVATION

WITTE

DFD Numbe

Set Type

LAYOUT NOTES MATERIALS LEGEND UIHLEIN/WILSON CURB DIMENSIONS ARE TO BACK OF CURB, UNLESS ALL WORK WITHIN THE RIGHT OF WAY SHALL CONFORM SMITHGROUP JJR 44 EAST MIFFLIN STREET SUITE 600 MADISON, WI 53703 606.251.1177 (TO1R) OTHERWISE NOTED. TO CITY OF MADISON STANDARDS AND GENERAL ASPHALT PAVEMENT ORDINANCES. 2 C701B ALL DIMENSIONS MUST BE FIELD VERIFIED AND ANY 8.1. ALL SIDEWALK, INCLUDING EXPANSION JOINT HD CONCRETE SIDEWALK DISCREPANCIES REPORTED TO THE OWNER'S PLACEMENT AND MATERIALS, SHALL BE PER CITY (4 C701R REPRESENTATIVE IMMEDIATELY. CONCRETE SIDEWALK 8.2. ANY FULL DEPTH PAVEMENT REPLACEMENT SHALL 10, 11 C701B ADJUST LAYOUT AS DIRECTED BY THE ARCHITECT TO BE CITY OF MADISON TYPE C PAVEMENT. 5.25" HMA STANDARD CURB AND GUTTER **ENSURE PROPER CONNECTION TO EXISTING FACILITIES** TYPE E-3, 4" GRADATION NO.2, 6" GRADATION NO. 1 SEE NOTES FOR CITY AND SITE AMENITIES. 8.3. N. FRANCES STREET CURB SHALL BE CITY OF STANDARD TYPES. MADISON STANDARD TYPE "A" State of Wisconsin Department of Administration Division of Facilities Developr 10, 11 C701R PROPOSED CURBS TO BE FIELD STAKED FOR APPROVAL 8.4. W. DAYTON STREET CURB SHALL BE CITY OF FLUSH CURB AND GUTTER -OF THE LANDSCAPE ARCHITECT PRIOR TO INSTALLATION. MADISON STANDARD TYPE "H" SEE CITY OF MADISON 8.5. DETAILS CAN BE FOUND AT STANDARD DETAIL 3.02 WHERE PROPOSED DRIVE/SIDEWALK ABUTS EXISTING http://www.cityofmadison.com/business/pw/documents/ DRIVE/SIDEWALK, JOINT PATTERNS SHALL MATCH AND StdSpecs/2017/Part8.pdf CURB TRANSITION SUPERCEDE JOINT PATTERNS SHOWN ON PLANS. $\langle 17 \rangle$ PAVEMENT PATCHING IN THE RIGHT OF WAY SHALL BE **CONTROL JOINT** C701R SET AUXILIARY BENCHMARKS AS REQUIRED TO LAYOUT PER CITY'S PATCHING CRITERIA: ANY PATCHES WITHIN 18 C702R $\langle 21 \rangle$ AND CONSTRUCT WORK. 100 FT. OF EACH OTHER SHALL BE COMBINED INTO A **DETECTABLE WARNING PLATE** SINGLE LARGER PATCH. PATCHES ARE A MINIMUM OF 2" $\left\langle 33\right\rangle$ PAVING RADII SHALL BE FORMED COMPLETELY AND **BRICK PAVERS** MILL AND OVERLAY. SMOOTHLY TRANSITION INTO TANGENTS AND ADJOINING $\langle 37 \rangle$ LINES. FLAT CURVE SEGMENTS IN HORIZONTAL LAYOUT VEHICULAR AND BIKE PARKING FACILITIES ARE DESIGNED SAWCUT SIDEWALK/DRIVE -SHALL BE REMOVED AND REPLACED AT NO COST TO TO MEET THE UNIVERSITY OF WISCONSIN-MADISON AND TYPE III TRENCH PATCHES AT OWNER. STATE OF WISCONSIN REQUIREMENTS. UTILITY TRENCH WORK WITHIN THE STREET. MATERIALS NOTES SEE EXISTING CONDITIONS PLAN C101 FOR LEGEND OF EXISTING FEATURES, PROJECT BENCHMARKS, VERTICAL Madison AND HORIZONTAL CONTROL POINTS. HATCH PATTERNS ARE FOR REFERENCE ONLY, HATCHES DO NOT REPRESENT DIRECTIONAL LAYOUT OR PATTERN Wisconsin OF MATERIALS. WITTE RENOVATION SID SEE SHEET C501R & C502R FOR GRADING SEE SHEET C801R & C802R FOR PLANTING PLAN. o 0 18"VP (11) TYPE A M.E. /-7.00' lo. Date: ₩E HALL CONSIN S 0 2 DAVIDK WOLMUTT SNH E-31264 SCALE 1 : 30 Graphic Scale O. DFD Number 8.50' NORTH FRANCES STREET 8.50' 27.00' S Set Type 113.83 C402R

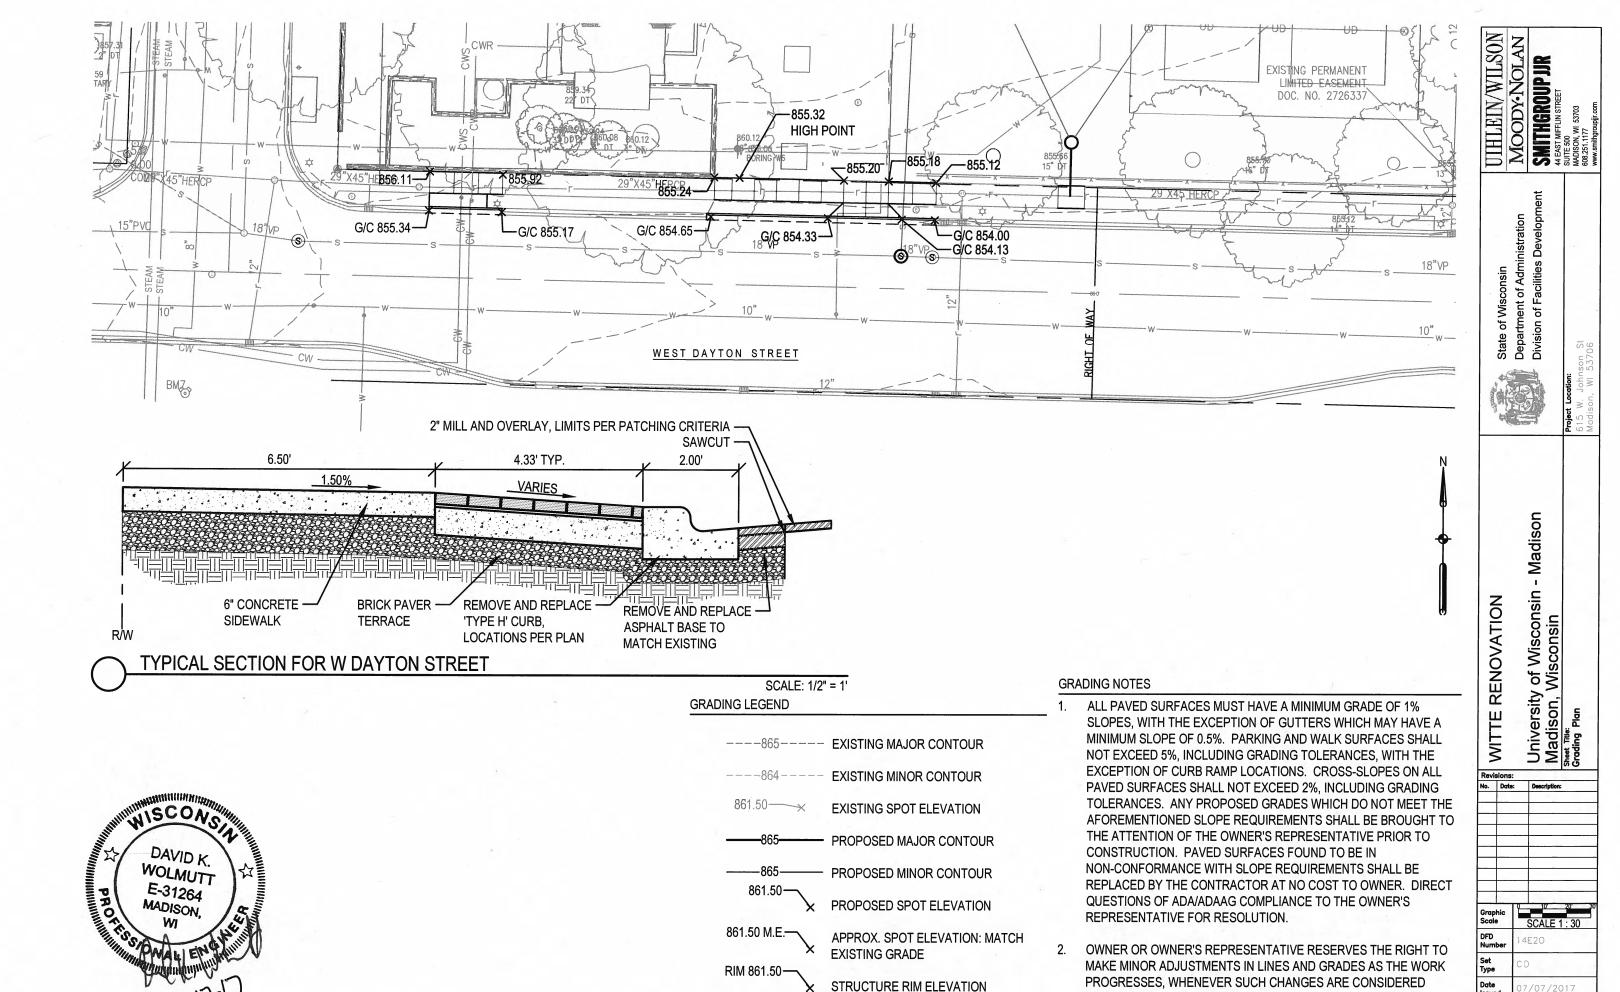

G/C 861.50-

GUTTER OF CURB ELEVATION


(FLOW LINE)


7/07/2017

C501R


NECESSARY TO BETTER ACCOMPLISH THE DESIGN INTENT OR TO


OBTAIN A BETTER BALANCE OF CUT AND FILL.

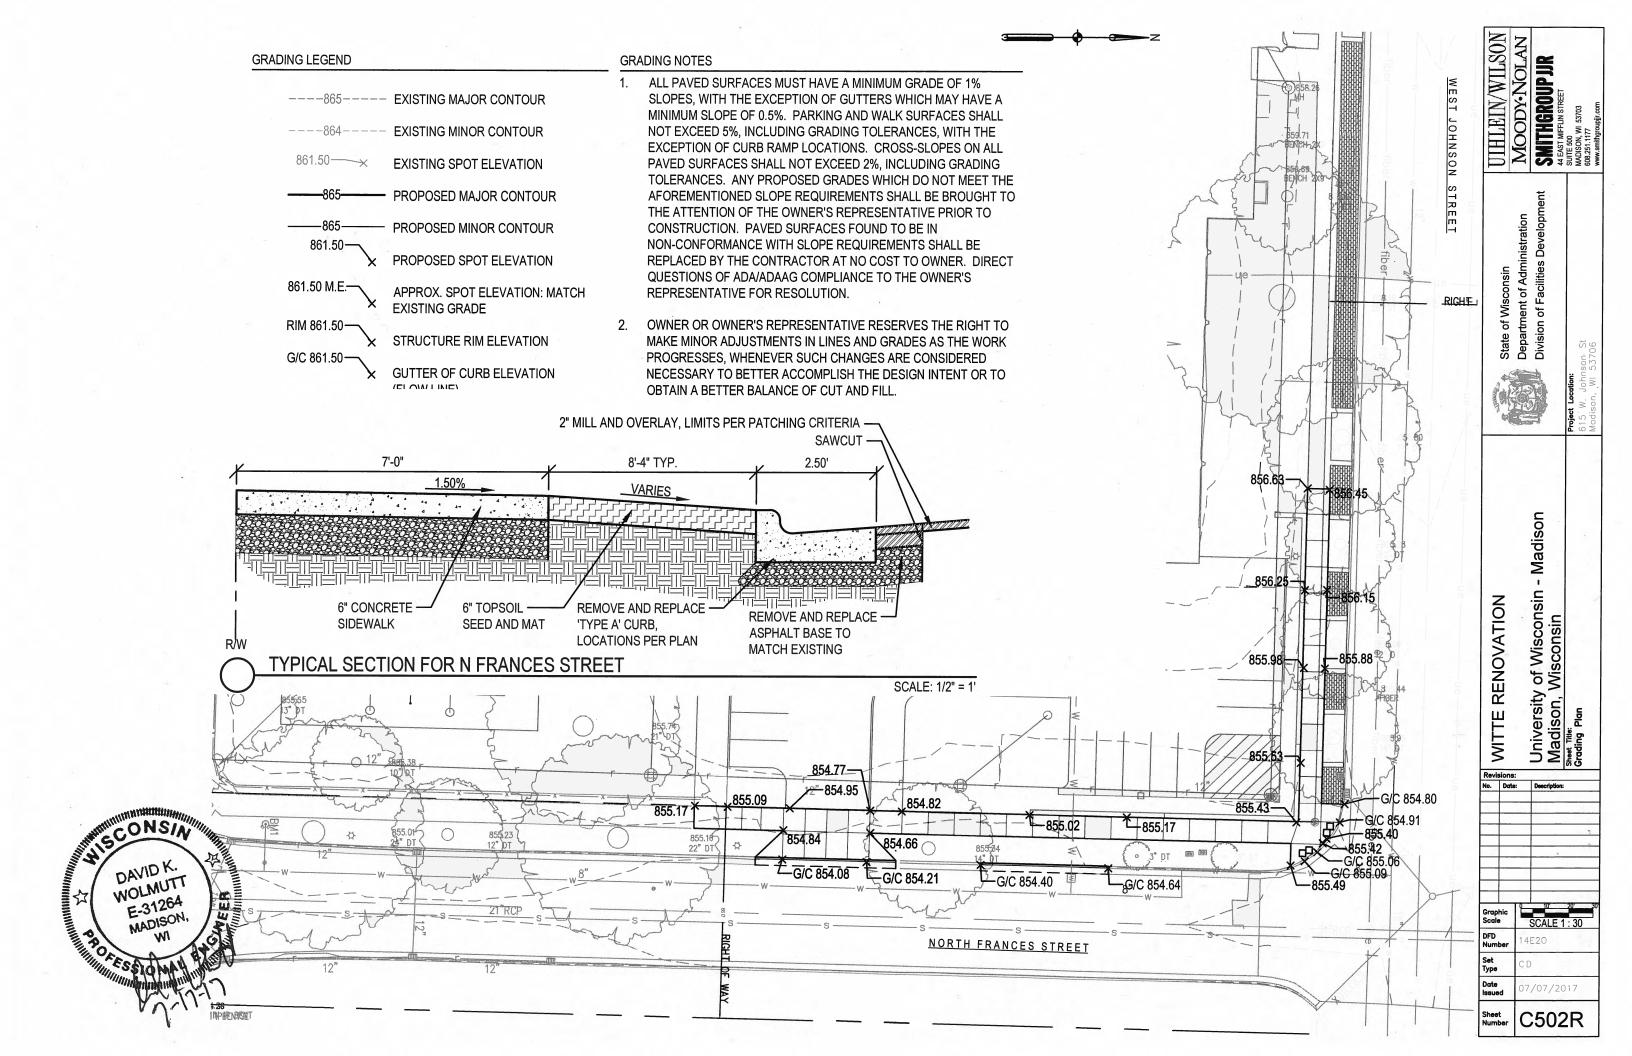

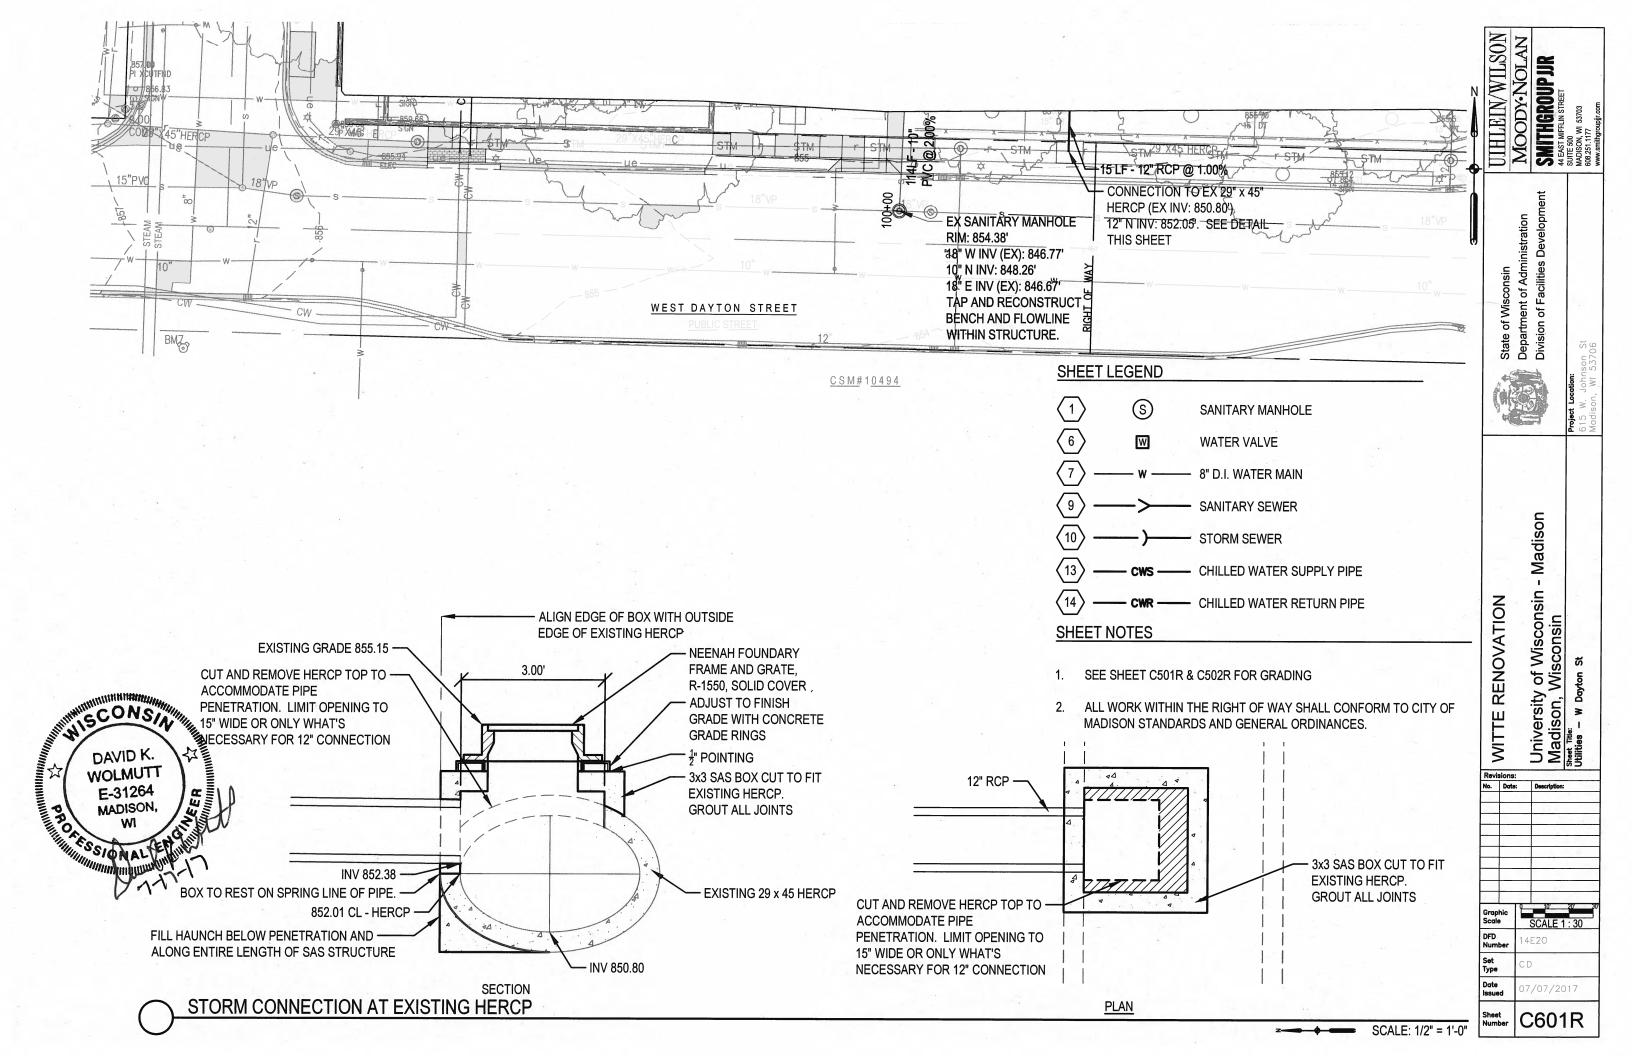

UIHLEIN/WILSON MOODY-NOLAN SMITHGROUP JIR 44 EAST MIFFLIN STREET SUITE SOO MADISON, WI 53703 609.251.1177 SHEET LEGEND $\langle 1 \rangle$ S SANITARY MANHOLE NOSNHOL 6W WATER VALVE 8" D.I. WATER MAIN STREET SANITARY SEWER STORM SEWER State of Wisconsin Department of Administration Division of Facilities Developme CHILLED WATER SÚPPLY PIPE CHILLED WATER RETURN PIPE RIGHT OF WAY SHEET NOTES 1. SEE SHEET C501R & C502R FOR GRADING ALL WORK WITHIN THE RIGHT OF WAY SHALL CONFORM TO CITY OF MADISON STANDARDS AND GENERAL ORDINANCES. ALL WATER SERVICE WORK IS TO BE COMPLETED PER CITY OF MADISON STANDARD SPECIFICATIONS AND DETAILS - SERIES 7. - Madison of Wisconsin - Wisconsin WITTE RENOVATION HISCONS ☆ DAVID K. WOLMUTT E-31264 6 MADISON SCALE 1 : 30 NORTH FRANCES STREET PUBLIC STREET - 150 LF - 8" D.I. WATER MAIN - CONNECT TO EXISTING 8" WATER MAIN Set Type 07/07/2017 HOYT'S SUDV OF BLOCK 12 UNIVERSITY ADDITION TO MADISON BLOCK 1 C602R

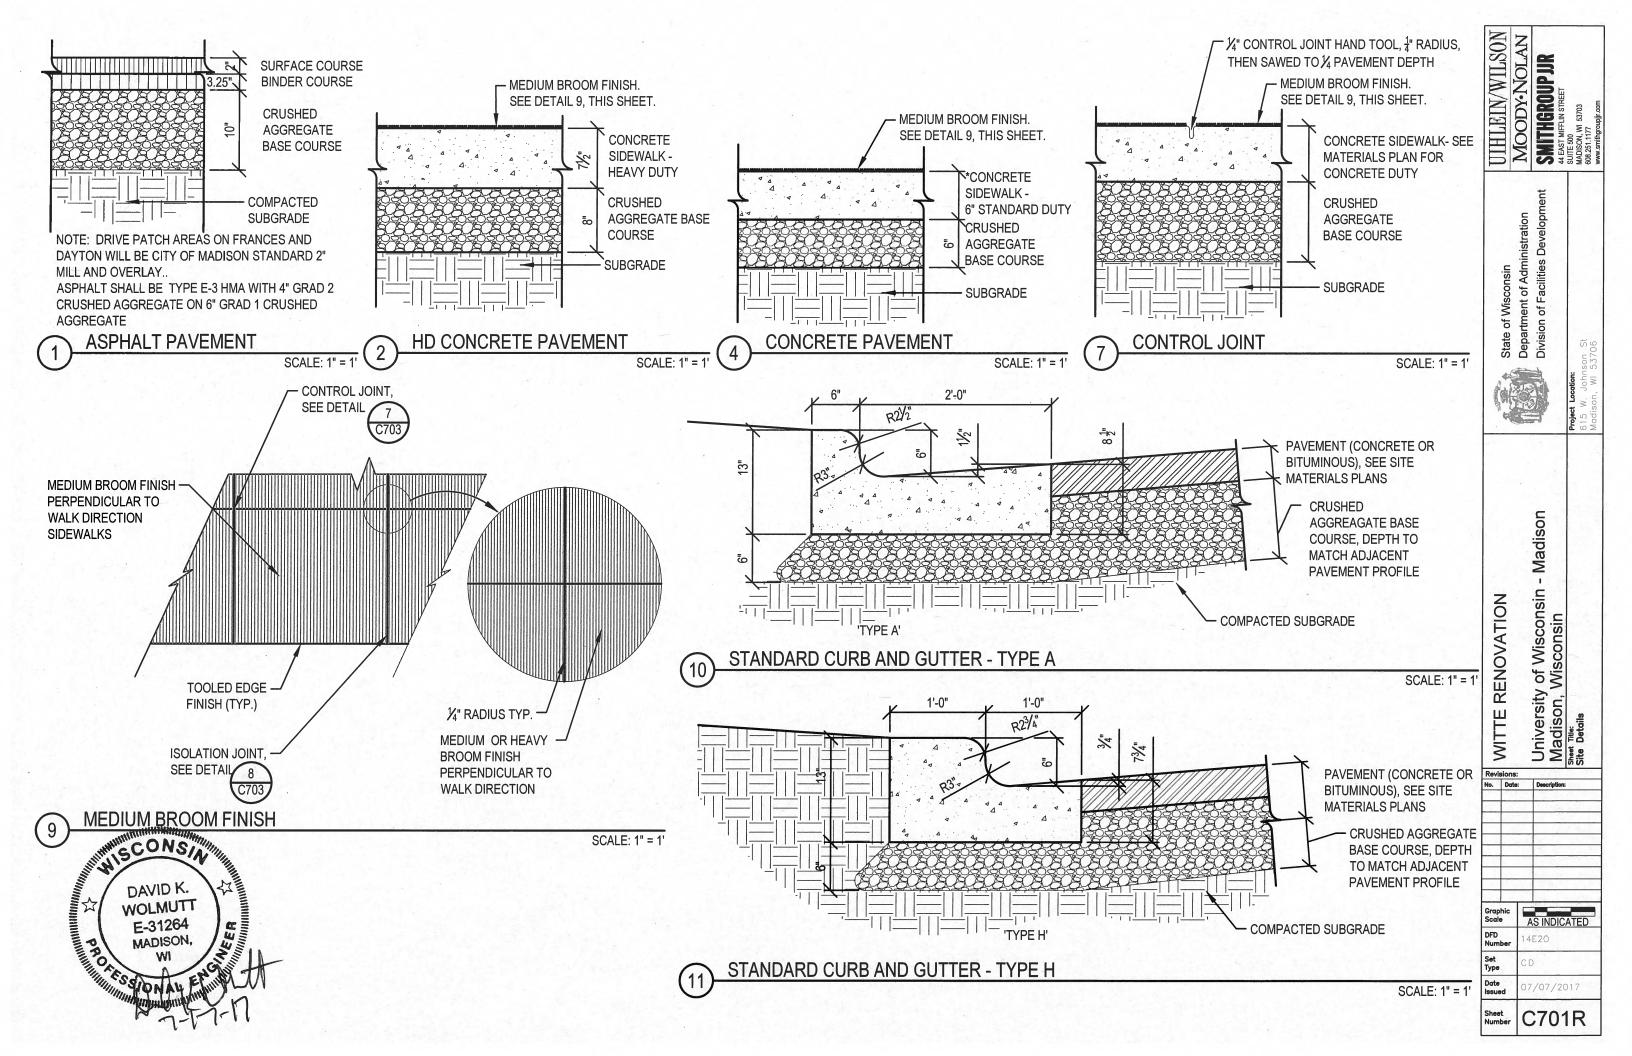


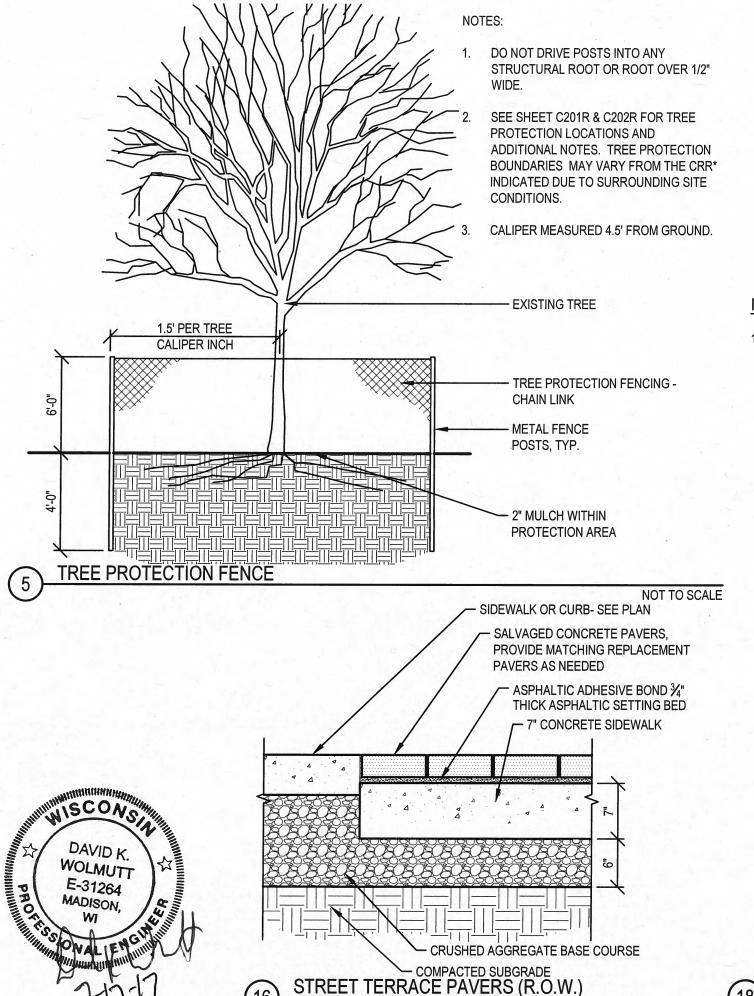

NOTES:

. DETECTABLE WARNING SURFACE:

- DETECTABLE WARNING SHALL BE NEENAH FOUNDRY R-4984 CAST IRON PLATE, NATURAL FINISH.
- b. TRUNCATED DOMES IN A DETECTABLE WARNING SURFACE SHALL HAVE A BASE DIAMETER OF 0.9" MINIMUM TO 1.4" MAXIMUM, A TOP DIAMETER OF 50% OF THE BASE DIAMETER MINIMUM TO 65% OF THE BASE DIAMETER MAXIMUM AND A HEIGHT OF 0.2".
- TRUNCATED DOMES IN A DETECTABLE WARNING SURFACE SHALL HAVE A CENTER-TO-CENTER SPACING OF 1.6" MINIMUM AND 2.4" MAXIMUM, AND A BASE-TO-BASE SPACING OF 0.65" MINIMUM, MEASURED BETWEEN THE MOST ADJACENT DOMES ON SQUARE GRID.
- d. THE DETECTABLE WARNING SURFACE SHALL BE LOCATED SO THAT THE EDGE NEAREST THE CURB LINE IS 6" MINIMUM AND 8" MAXIMUM FROM THE CURB LINE.
- IN LOCATIONS WHERE THE RAMP IS SKEWED TO THE CURB, THE DETECTABLE WARNING SURFACE IS TO RUN PERPENDICULAR TO THE DIRECTION OF TRAVEL.

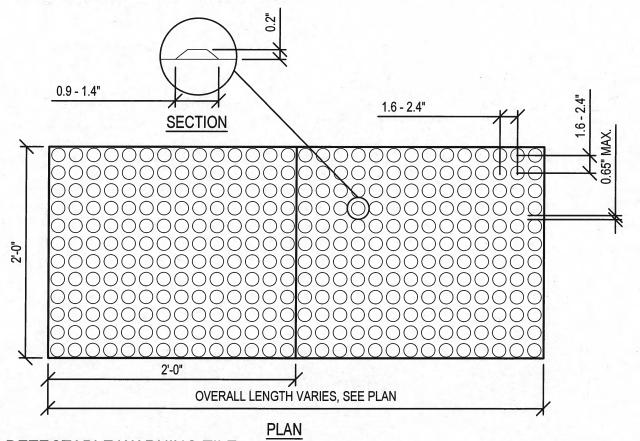

- Madison y of Wisconsin Wisconsin WITTE RENOVATION University of Madison, Value Details No. Date: AS INDICATED DFD Number Set Type Date Issued 7/07/2017 C702R

JIHLEIN/WILSON

SMITHGROUPJIR 44 EAST WIFELIN STREET SUITE 500 MADISON, WI 53703 668-251.177


Department of Administration Division of Facilities Developn

State of Wiscor


DETECTABLE WARNING TILE

SCALE: 1" = 1'

SCALE: N.T.S.

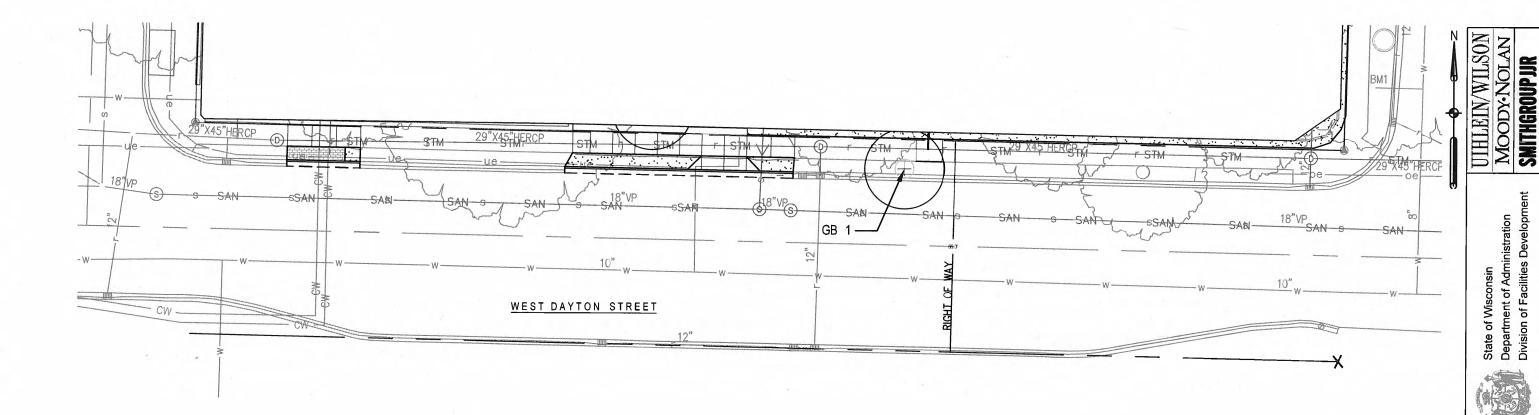

LANDSCAPE LEGEND

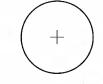

DECIDUOUS SHADE TREE



LAWN MINERAL BASED SOD


LANDSCAPE NOTES


- 1. PRIOR TO CONSTRUCTION ACTIVITIES, CONTRACTOR SHALL CALL DIGGERS HOTLINE TO LOCATE SITE UTILITIES.
- 2. CONTRACTOR SHALL CONTACT CITY FORESTRY AT LEAST ONE WEEK PRIOR TO PLANTING TO SCHEDULE INSPECTING THE NURSERY STOCK AND REVIEWING PLANTING SPECIFICATIONS WITH LANDSCAPE CONTRACTOR. ALL STREET TREE LOCATIONS AND TREE SPECIES WITHIN THE RIGHT OF WAY SHALL BE REVIEWED AND APPROVED BY CITY FORESTRY. CONTACT DEAN KAHL AT CITY FORESTRY, dkahl@cityofmadison.com, 266-4816.
- 3. ALL EXISTING TREES SHALL RECEIVE A MINIMUM 3" THICK MULCH RING, 6' IN DIAMETER. ALL PROPOSED TREES TO RECEIVE A 3' DIAMETER MULCH RING. INCLUDES TREES ON SITE AND IN CITY RIGHT OF WAY ALL TREES ALONG FRANCES STREET AND DAYTON STREET EVEN IF OUTSIDE OF NORMAL LIMITS OF WORK



	Plant List						
Key	Scientific Name	Common Name	Qty	Cond.	Size	Comments	
	Shade Trees						
СО	Shade Trees Celtis Occidentalis	Hackberry	1	B&B	3" Cal.	Space as shown	
CO	1 12 12 12 12 12 12 12 12 12 12 12 12 12	Hackberry Princton Sentry Ginkgo	1 1	B&B B&B	3" Cal.	Space as shown Space as shown	



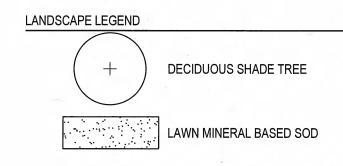

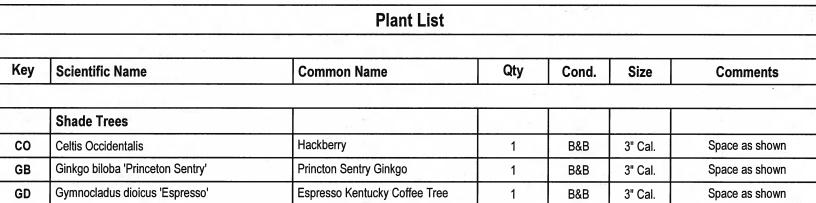

LANDSCAPE NOTES

PRIOR TO CONSTRUCTION ACTIVITIES, CONTRACTOR SHALL CALL DIGGERS HOTLINE TO LOCATE SITE UTILITIES.

UTHLEIN/WILSON
MOODY-NOLAN
SMITHGROUP JIR
44 EAST MIFLIN STREET
WADISON, WI 53703
G00 251 1177

- CONTRACTOR SHALL CONTACT CITY FORESTRY AT LEAST ONE WEEK PRIOR TO PLANTING TO SCHEDULE INSPECTING THE NURSERY STOCK AND REVIEWING PLANTING SPECIFICATIONS WITH LANDSCAPE CONTRACTOR. ALL STREET TREE LOCATIONS AND TREE SPECIES WITHIN THE RIGHT OF WAY SHALL BE REVIEWED AND APPROVED BY CITY FORESTRY. CONTACT DEAN KAHL AT CITY FORESTRY, dkahl@cityofmadison.com, 266-4816.
- ALL EXISTING TREES SHALL RECEIVE A MINIMUM 3" THICK MULCH RING, 6' IN DIAMETER. ALL PROPOSED TREES TO RECEIVE A 3' DIAMETER MULCH RING. INCLUDES TREES ON SITE AND IN CITY RIGHT OF WAY - ALL TREES ALONG FRANCES STREET AND DAYTON STREET EVEN IF OUTSIDE OF NORMAL LIMITS OF WORK

