

INDEX OF SHEETS

SHEET NO.D1 GENERAL NOTES SHEET NO.D2 TYPICAL SECTION

SHEET NO.P1-P3 STREET PLAN & PROFILES

SHEET NO. U1 **UTILITY PLAN**

SHEET NO.C6.1 STORM SEWER PROFILE

SHEET NO.C8.1 DETAIL SHEET

SHEET NO.C8.3 **BIORETENTION DETAIL**

SHEET NO. X1-X3 **CROSS SECTION**

NO MAINTENANCE PLAN

CITY OF MADISON CITY ENGINEERING DIVISION


DEPARTMENT OF PUBLIC WORKS PLAN OF PROPOSED IMPROVEMENT

2651 EAST SPRINGS DRIVE

CITY PROJECT NO. 14045

CONTRACT NO. 9153

PROJECT LOCATION

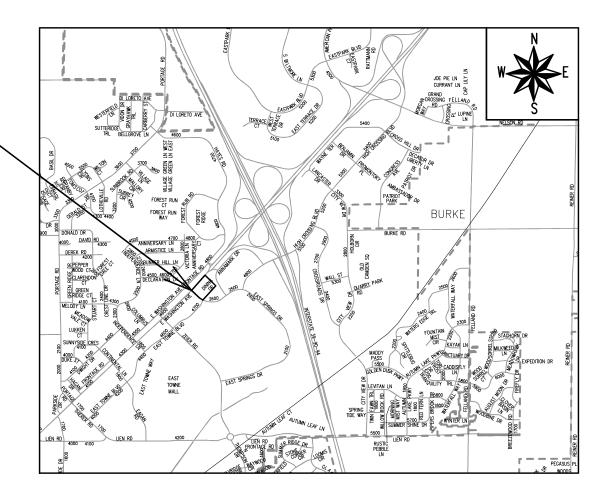

PUBLIC IMPROVEMENT PROJECT

MARCH 01,2022

BY THE COMMON COUNCIL OF MADISON, WISCONSIN

PUBLIC IMPROVEMENT DESIGN APPROVED BY:

N- Greg Fries

Jun 13, 2022

City Engineer

STREET DESIGNED BY:



SANITARY SEWER **DESIGNED BY:**

> LATERAL ONLY

STORM SEWER DESIGNED BY:

LATERAL ONLY

WATER **DESIGNED BY:**

> *LATERAL* ONLY

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ALL PROPOSED STREET TREE REMOVALS WITHIN THE RIGHT OF WAY SHALL BE REVIEWED BY CITY FORESTRY BEFORE THE PLAN COMMISSION MEETING. STREET TREE REMOVALS REQUIRE APPROVAL AND A TREE REMOVAL PERMIT ISSUED BY CITY FORESTRY. ANY STREET TREE REMOVALS REQUESTED AFTER THE DEVELOPMENT PLAN IS APPROVED BY THE PLAN COMMISSION OR THE BOARD OF PUBLIC WORKS AND CITY FORESTRY WILL REQUIRE A MINIMUM OF A 72-HOUR REVIEW PERIOD WHICH SHALL INCLUDE THE NOTIFICATION OF THE ALDERPERSON WITHIN WHO'S DISTRICT IS AFFECTED BY THE STREET TREE REMOVAL(S) PRIOR TO A TREE REMOVAL PERMIT BEING ISSUED.

AS DEFINED BY THE SECTION 107.13 OF CITY OF MADISON STANDARD SPECIFICATIONS FOR PUBLIC WORKS CONSTRUCTION: NO EXCAVATION IS PERMITTED WITHIN 5 FEET OF THE TRUNK OF THE STREET TREE OR WHEN CUTTING ROOTS OVER 3 INCHES IN DIAMETER. IF EXCAVATION IS NECESSARY, THE CONTRACTOR SHALL CONTACT CITY OF MADISON FORESTRY (266-4816) PRIOR TO EXCAVATION. CITY OF MADISON FORESTRY PERSONNEL SHALL ASSESS THE IMPACT TO THE TREE AND TO ITS ROOT SYSTEM PRIOR TO WORK COMMENCING. TREE PROTECTION SPECIFICATIONS CAN BE FOUND ON THE FOLLOWING WEBSITE: HTTPS://WWW.CITYOFMADISON.COM/BUSINESS/PW/SPECS.CFM

DEVELOPER MUST SUBMIT A TRAFFIC CONTROL PLAN TO CITY TRAFFIC ENGINEERING AT LEAST 14 DAYS PRIOR TO THE START OF WORK. WORK SHALL NOT PROCEED UNTIL AN APPROVED TRAFFIC CONTROL PLAN IS IN PLACE.

CONTACT PROJECT ENGINEER AND STREET DESIGNER DAYENU SIMON AT DSIMON@CITYOFMADISON.COM FOR CAD AND ALIGNMENT DATA PRIOR TO STAKING.

CONVENTIONAL	L SIGNS
FIELD VERIFY ALL UTIL	ITY LOCATIONS
GAS	—— G ——
STORM SEWER	—— ST ——
SANITARY SEWER	SN
WATER	—— w ——
BURIED ELECTRIC	—— E ——
OVERHEAD ELECTRIC	——— OH———
POWER POLE	占
ADA COMPLIANT RAMP V DETECTABLE WARNING	'
COMBUSTIBLE FLUIDS	-CANTONIO

UNDERDRAINS SHALL BE INSTALLED PER STANDARD DETAIL DRAWING 4.05 FOR 75' ON EACH SIDE OF THE LOW POINT, OR TO THE NEAREST CURB HIGH POINT. ALL UNDERDRAIN SHALL BE WRAPPED.

ALL GUTTERS SHALL DRAIN WITH A MINIMUM GRADE OF 0.5% TOWARD STORM SEWER INLETS.

ALL DITCHES SHALL DRAIN WITH A MINIMUM GRADE OF 0.5%

THE CROSS SLOPE OF SIDEWALKS AND BARRIER FREE SIDEWALK CURB RAMPS SHALL TYPICALLY BE 1.5%. THE LONGITUDINAL GRADE OF BARRIER FREE SIDEWALK CURB RAMPS SHALL NOT EXCEED 8.33%. ALL SIDEWALK RAMPS SHALL BE CONSTRUCTED ACCORDING TO S.D.D. 3.04. AT ALL OTHER LOCATIONS THE LONGITUDINAL GRADE OF SIDEWALKS SHALL NOT BE LESS THAN 0.5% AND SHALL DRAIN TOWARD STORM SEWER INLETS. ALL SIDEWALK AND SIDEWALK RAMP ELEVATIONS AND GRADES SHALL BE FIELD VERIFIED AND SET TO COMPLY WITH THE CITY OF MADISON STANDARD SPECIFICATIONS AND THE A.D.A. GUIDELINES.

CURB STATION AND OFFSETS SHALL BE TO THE EDGE OF PAVEMENT UNLESS OTHERWISE INDICATED. CURB ELEVATIONS SHALL BE TO THE EDGE OF PAVEMENT UNLESS OTHERWISE INDICATED.

POWER POLES AND OTHER OBSTRUCTIONS SHALL BE MOVED TO PROVIDE 2 FEET MINIMUM OF CLEAR DISTANCE FROM ANY FACE OF CURB OR EDGE OF SIDEWALK.

ANY INFORMATION SHOWN ON THIS PLAN, WHICH IS NOT PART OF THIS RIGHT-OF-WAY PROJECT, IS PRELIMINARY AND NOT FOR CONSTRUCTION.

THERE MAY BE EXISTING UTILITIES OR OTHER FEATURES WHICH ARE EITHER NOT SHOWN OR SHOWN INCORRECTLY ON THIS PLAN. IT IS THE RESPONSIBILITY OF THE DEVELOPER TO LOCATE AND IDENTIFY ALL UTILITIES AND TOPOGRAPHY WHICH MAY AFFECT THE CONSTRUCTION OF THESE IMPROVEMENTS.

ALL PERMANENT SIGNING AND POSTING WILL BE DETERMINED AND PROVIDED BY THE TRAFFIC ENGINEERING DIVISION, FOLLOWING CONSTRUCTION OF THESE IMPROVEMENTS.


THE DEVELOPER SHALL PROVIDE, INSTALL AND MAINTAIN ALL STREET END BARRICADES, SIGNING AND TRAFFIC CONTROL, AS REQUIRED BY THE CITY TRAFFIC ENGINEER.

PAVEMENT SAWCUTS SHALL BE AS DIRECTED BY THE CITY CONSTRUCTION ENGINEER. SAWCUTS SHOWN ON THE PLAN ARE APPROXIMATE.

ALL WORK IN THE RIGHT OF WAY AND PUBLIC EASEMENTS SHALL BE IN ACCORDANCE WITH THE CITY OF MADISON STANDARD SPECIFICATIONS FOR PUBLIC WORKS CONSTRUCTION


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TYPICAL SECTION

E SPRINGS DRIVE NOT TO SCALE

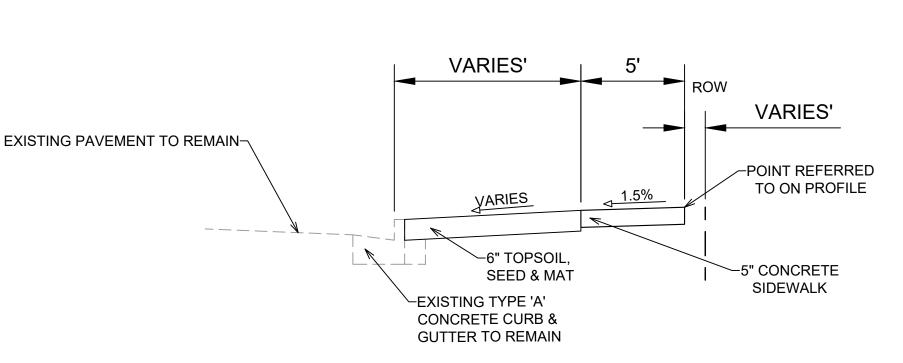

TYPICAL SECTION


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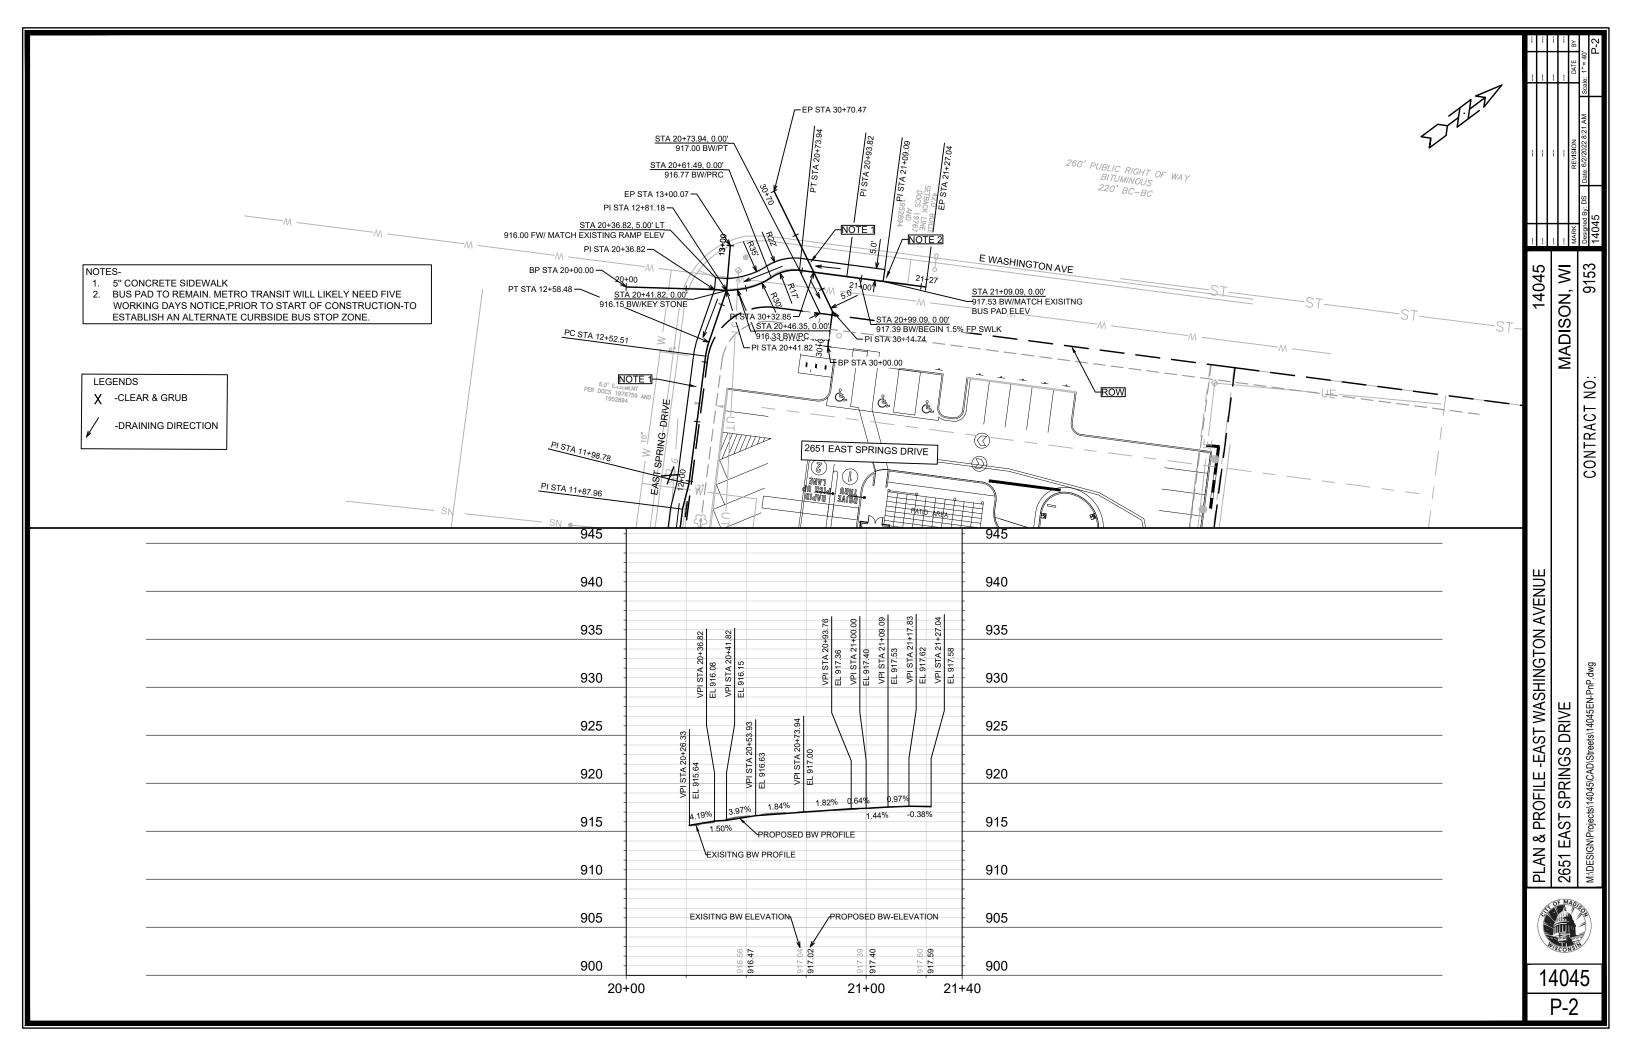
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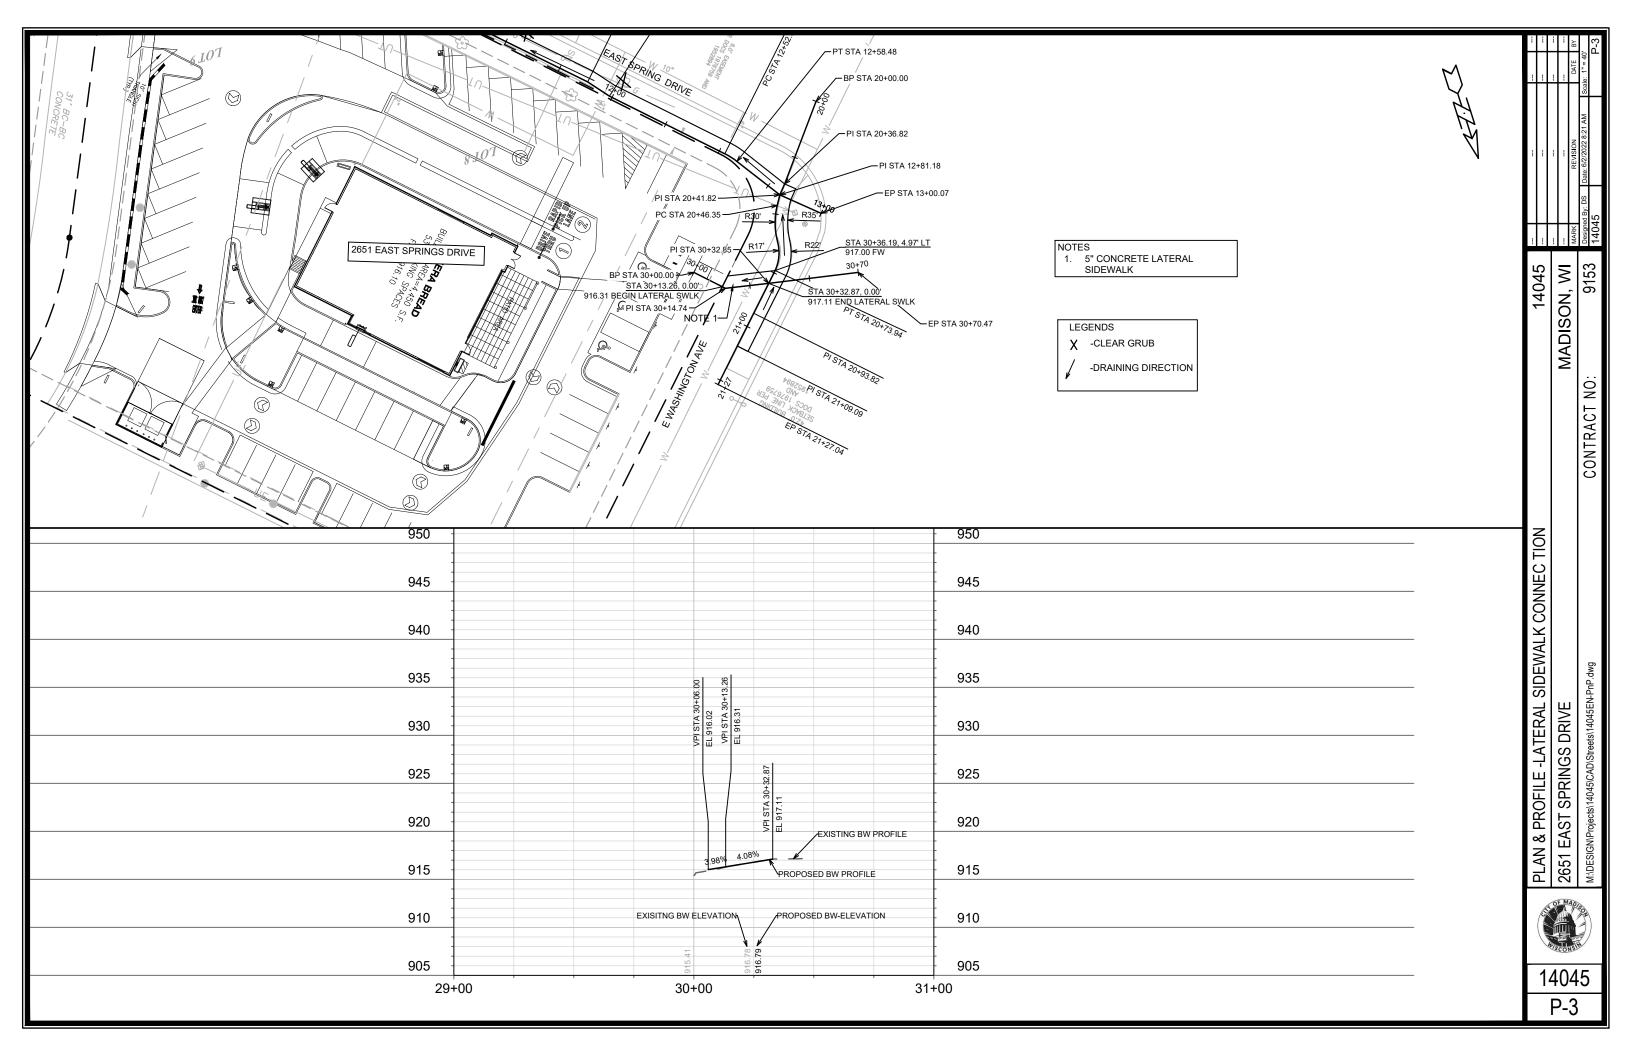


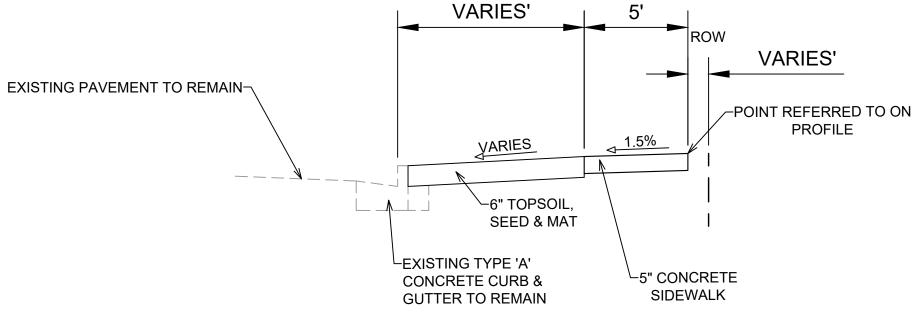
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KEYED NOTES

GAS SERVICE

- 1. NEW GAS SERVICE POINT OF CONNECTION. ALL MATERIAL AND INSTALLATION BY AT THE CONTRACTORS EXPENSE. THE CONTRACTOR SHALL CONTACT AS SOON AS POSSIBLE TO ACCOMMODATE REQUIRED LEAD TIME FOR DESIGN AND COORDINATION OF THE NEW SERVICE.
- NEW 2" GAS SERVICE. ALL MATERIAL AND INSTALLATION BY GAS UTILITY AT THE CONTRACTOR'S EXPENSE.
- NEW GAS METER. ALL MATERIAL AND INSTALLATION BY GAS UTILITY AT THE CONTRACTORS EXPENSE.
- 4. REFER TO ARCHITECTURAL PLANS FOR EXACT LOCATION AND CONTINUATION OF GAS SERVICE.

WATER SER

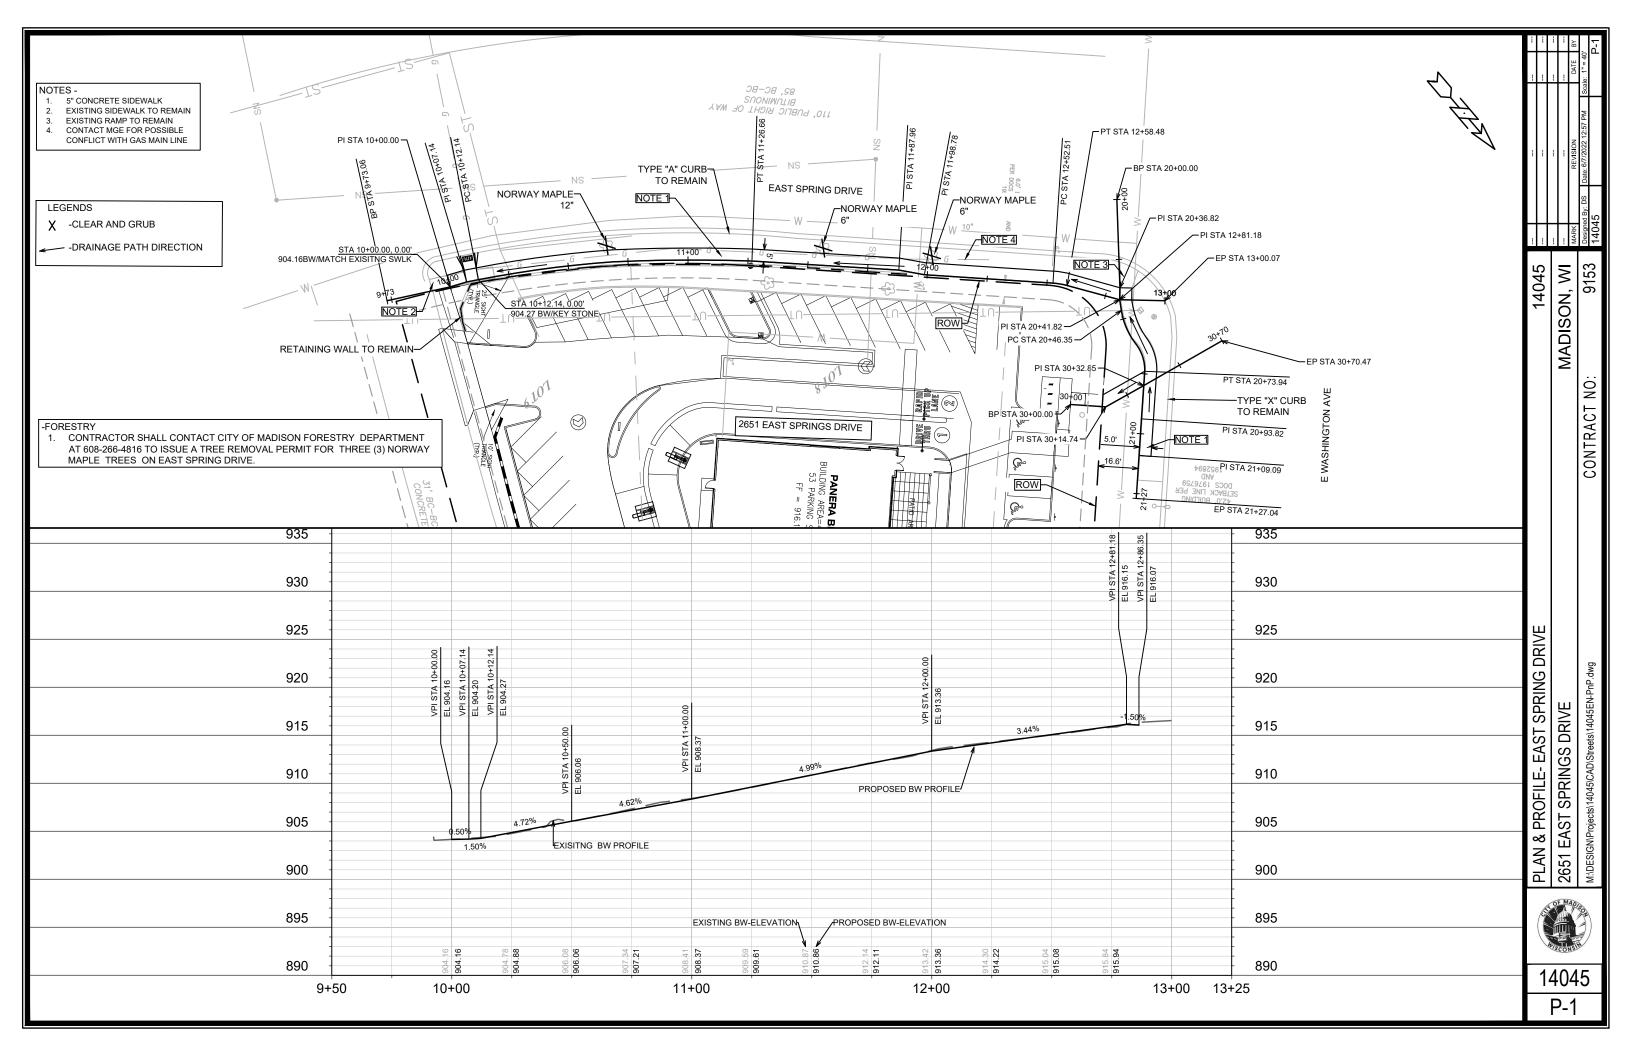5. NOT USED.

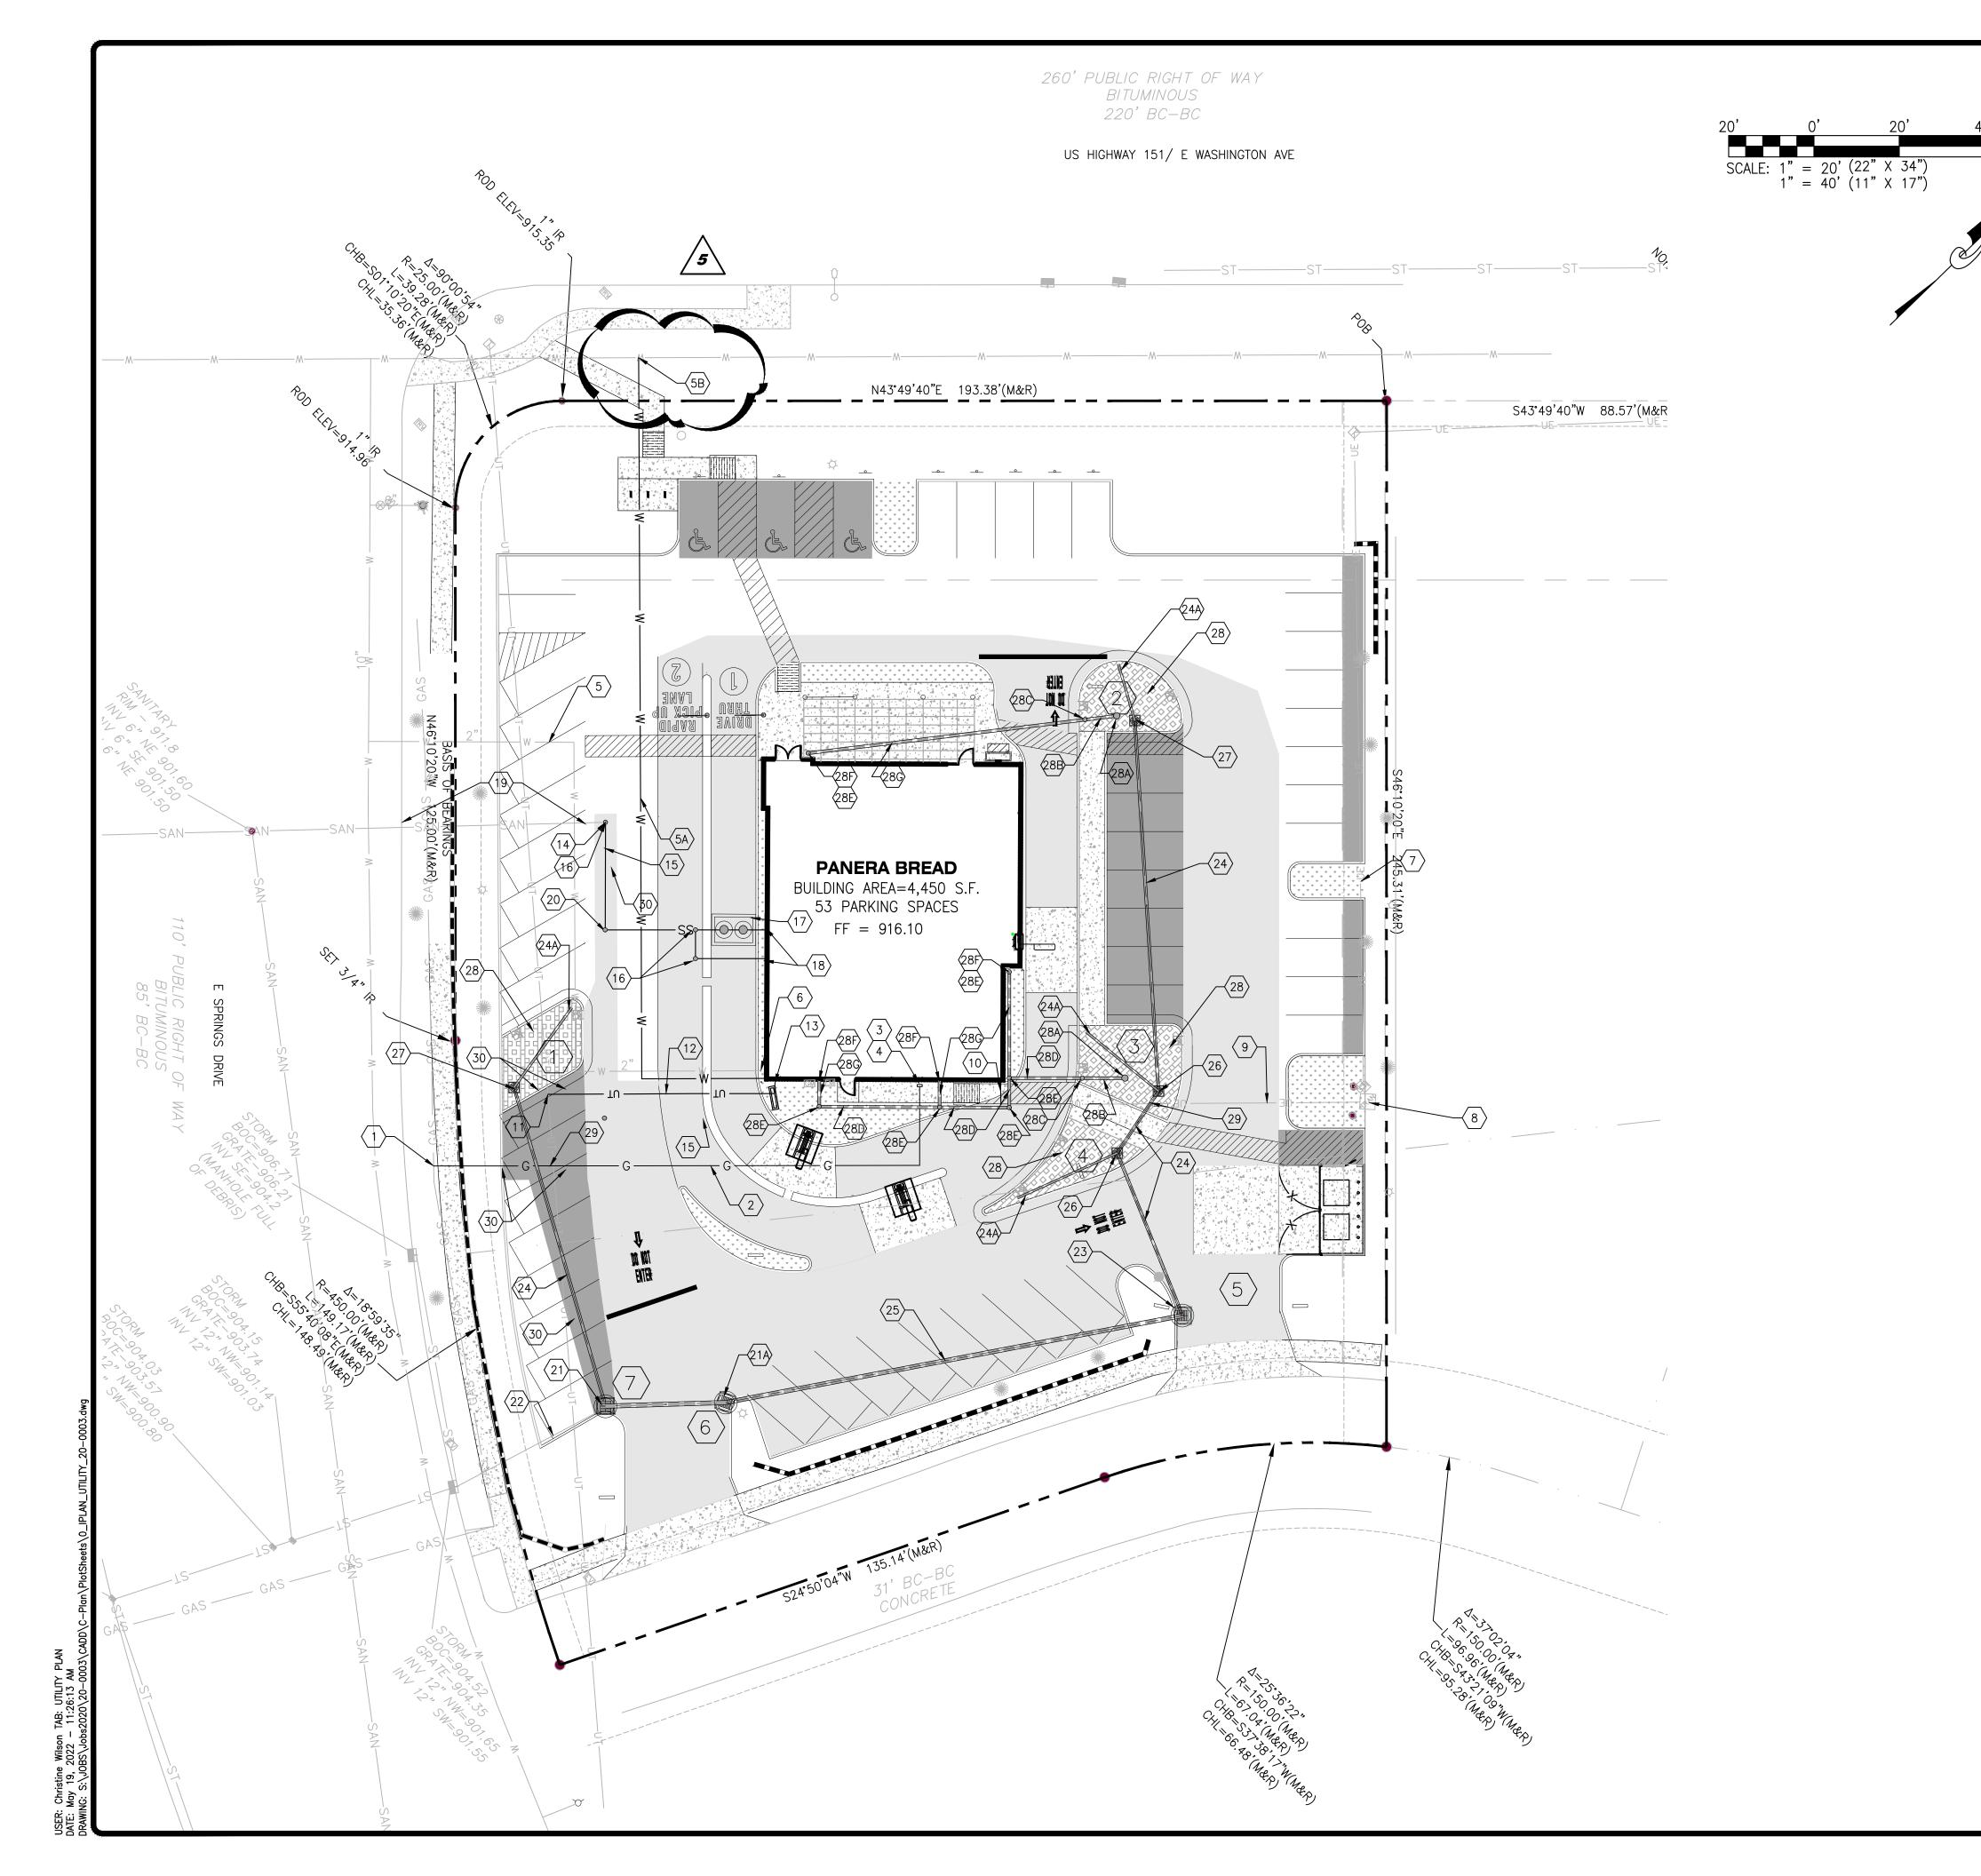- 5A. NEW 6" FIRE/DOMESTIC WATER SERVICE. WATER SERVICE LINE TO BE DUCTILE IRON PIPE FROM MAIN TO RIGHT-OF-WAY LINE AND PVC FROM RIGHT-OF-WAY LINE TO BUILDING. FINAL FIRE SERVICE LINE SIZE SHALL BE VERIFIED BY THE FIRE SPRINKLER CONTRACTOR PRIOR TO THE START OF CONSTRUCTION.
- 5B. CONTRACTOR TO COORDINATE WITH THE UTILITY COMPANY FOR A LIVE TAP TO THE EXISTING WATER MAIN
- . REFER TO ARCHITECTURAL PLANS FOR EXACT LOCATION AND CONTINUATION OF DOMESTIC WATER SERVICE.
- 7. EXISTING PRIMARY UNDERGROUND ELECTRIC SERVICE TO BE USED IN
- 8. EXISTING GROUND MOUNTED TRANSFORMER TO BE USED IN PLACE.
 9. EXISTING SECONDARY UNDERGROUND ELECTRIC SERVICE TO BE USED
- 10. REFER TO ARCHITECTURAL PLANS FOR EXACT LOCATION AND CONTINUATION OF ELECTRIC SERVICE.

COMMUNICATIONS SERVICE

- 11. NEW COMMUNICATIONS SERVICE POINT OF CONNECTION. ALL MATERIAL AND INSTALLATION BY UTILITY COMPANY AT THE CONTRACTORS EXPENSE. THE CONTRACTOR SHALL CONTACT COMMUNICATIONS UTILITY AS SOON AS POSSIBLE TO ACCOMMODATE REQUIRED LEAD TIME FOR DESIGN AND COORDINATION OF NEW SERVICE.
- 12. NEW PVC COMMUNICATION SERVICE CONDUIT. CONTRACTOR TO COORDINATE WITH UTILITY COMPANY FOR CONDUIT SIZING. THE CONTRACTOR SHALL BE RESPONSIBLE FOR PROVIDING AND INSTALLING THE CONDUIT AND PULLWIRE. ALL OTHER MATERIAL AND INSTALLATION BY COMMUNICATIONS UTILITY AT THE CONTRACTOR'S EXPENSE
- 13. REFER TO ARCHITECTURAL PLANS FOR EXACT LOCATION AND CONTINUATION OF COMMUNICATIONS SERVICE.

SANITARY SEWER SERVICE

- 14. NEW SANITARY SEWER SERVICE POINT OF CONNECTION TO EXISTING SANITARY LATERAL PER SANITARY SEWER UTILITY STANDARDS. INVERT ELEVATION = 908.46 (CONTRACTOR TO LOCATE EXISTING SANITARY SEWER AND VERIFY ELEVATION AT PROPOSED CONNECTION. REPORT FINDINGS TO ENGINEER). ALL MATERIAL AND INSTALLATION BY THE CONTRACTOR AT THE CONTRACTORS EXPENSE.
- 15. NEW 6" SANITARY SEWER SERVICE WITH 2.0% MINIMUM SLOPE AND 36" MINIMUM COVER.
- 16. NEW SANITARY SEWER CLEANOUT. REFER TO DETAIL ON SHEET C8.1.
 17. NEW GREASE TRAP. REFER TO ARCHITECTURAL PLANS
- 18. NEW SANITARY SEWER POINT OF BUILDING ENTRY (INVERT ELEVATION = 912.60). REFER TO ARCHITECTURAL PLANS FOR EXACT LOCATION AND CONTINUATION OF SANITARY SEWER SERVICE
- 19. EXISTING 6" SANITARY SEWER TO REMAIN.20. NEW SANITARY SAMPLING TEE. REFER TO DETAIL ON SHEET C8.1.

STORM SEWER SERVICE

- 21. NEW 2-GRATE INLET WITH SIDE INTAKEW AND WITH ADS FLEXSTORM PURE INLET FILTER WITH PC & FILTER BAG (OR APPROVED EQUAL). [EXISTING INVERT (SW)= 902.60]. CONTRACTOR TO VERIFY ELEVATION. REFER TO PROFILES ON SHEET C6.1.
- 21A. NEW 2-GRATE INLET WITH SIDE INTAKE AND WITH ADS FLEXSTORM PURE INLET FILTER WITH PC & FILTER BAG (OR APPROVED EQUAL). REFER TO PROFILES ON SHEET C6.1.
- 22. EXISTING 12" STORM SEWER TO REMAIN.
 23. NEW 2-GRATE INLET WITH SIDE INTAKE. REFER TO DETAIL ON
- SHEET C8.3 AND PROFILES ON SHEET C6.1.
- 24. NEW 8" PVC STORM SEWER. REFER TO PROFILES ON SHEET C6.1.
- 24A. NEW 6" PVC PERFORATED UNDERDRAIN. REFER TO SHEET C8.3
 25. NEW 12" PVC STORM SEWER. REFER TO PROFILES ON SHEET C6.1.
 26. NEW 12" NYLOPLAST DRAIN BASIN WITH DOME GRATE. REFER TO
- DETAIL ON SHEET C8.3 AND PROFILES ON SHEET C6.1.
 27. NEW 12" NYLOPLAST DRAIN BASIN WITH DOME GRATE. REFER TO
- DETAIL ON SHEET C8.3 AND PROFILES ON SHEET C6.1.

 28. NEW BIORETENTION BASIN. REFER TO DETAIL ON SHEET C8.3.

 28A. NEW PVC ROOF DRAIN RISER WITH PERFORATED SUMP WITH FILTER FABRIC SLEEVE IN BIORETENTION BASIN. REFER TO DETAIL 10 ON
- SHEET C8.1.

 28B.NEW 6" PERFORATED PVC ROOF DRAIN WITH FILTER FABRIC SLEEVE LINDER BIORETENTION BASIN ENGINEERED SOIL LAYER REFER TO
- UNDER BIORETENTION BASIN ENGINEERED SOIL LAYER. REFER TO DETAIL 10 ON SHEET C8.1.
- 28C.NEW ROOF DRAIN BIORETENTION CLEAN OUT. REFER TO DETAIL 10 ON SHEET C8.1.
 28D.NEW 6" PVC ROOF DRAIN WITH 2.00% MINIMUM SLOPE AND 36"
- MINIMUM COVER.

28E.NEW STORM SEWER CLEAN OUT.

28F.NEW ROOF DRAIN DOWNSPOUT CONNECTION (INVERT = 914.10). REFER TO MEP PLANS FOR EXACT LOCATION.
28G.NEW 4" PP ROOF DRAIN WITH 2.00% MINIMUM SLOPE AND 36" MINIMUM COVER.

28H.NEW CANOPY DRAIN POINT OF CONNECTION (INVERT = 914.10)
REFER TO MEP PLANS FOR EXACT LOCATION.

MISCELLANEOUS ITEMS

- 29. THE CONTRACTOR SHALL MAINTAIN 18" MINIMUM VERTICAL
- CLEARANCE AT ALL UTILITY CROSSINGS.
- 30. REMOVE ANOTEREPLACE EXISTING PAVEMENT, SIDEWALK, AND CURB IN KIND AS NECESSARY TO INSTALL THE PROPOSED UTILITIES.

 THE RIGHT-OF-WAY IS THE SOLE JURISDICTION OF THE CITY OF MADISON AND IS SUBJECT TO CHANGE AT ANY TIME PER THE RECOMMENDATION/PLAN OF TRAFFIC ENGINEERING AND CITY ENGINEERING DEPARTMENTS.

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3630 SOUTH GEYEF RO
ST. LOUIS, MO
(314) 984-10
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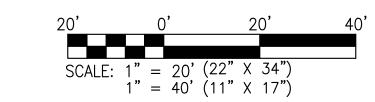
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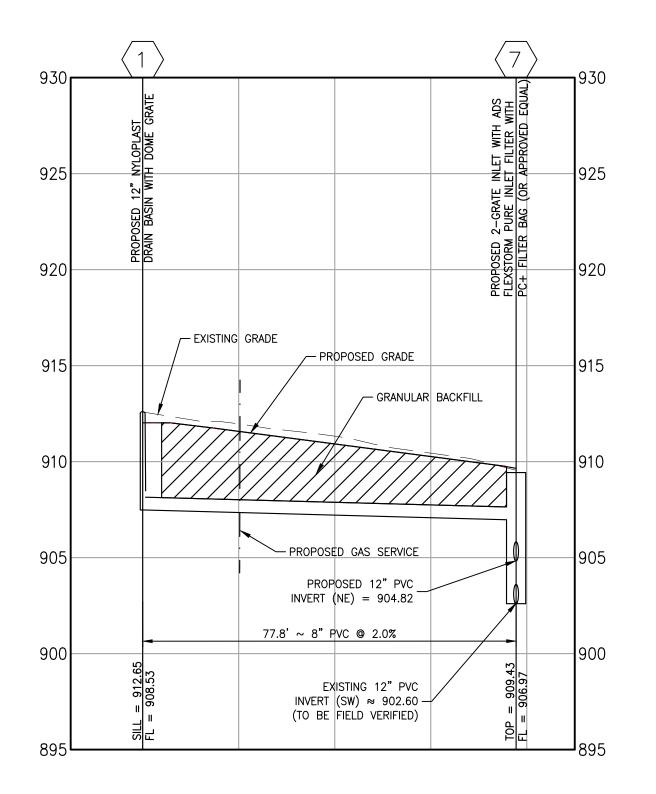
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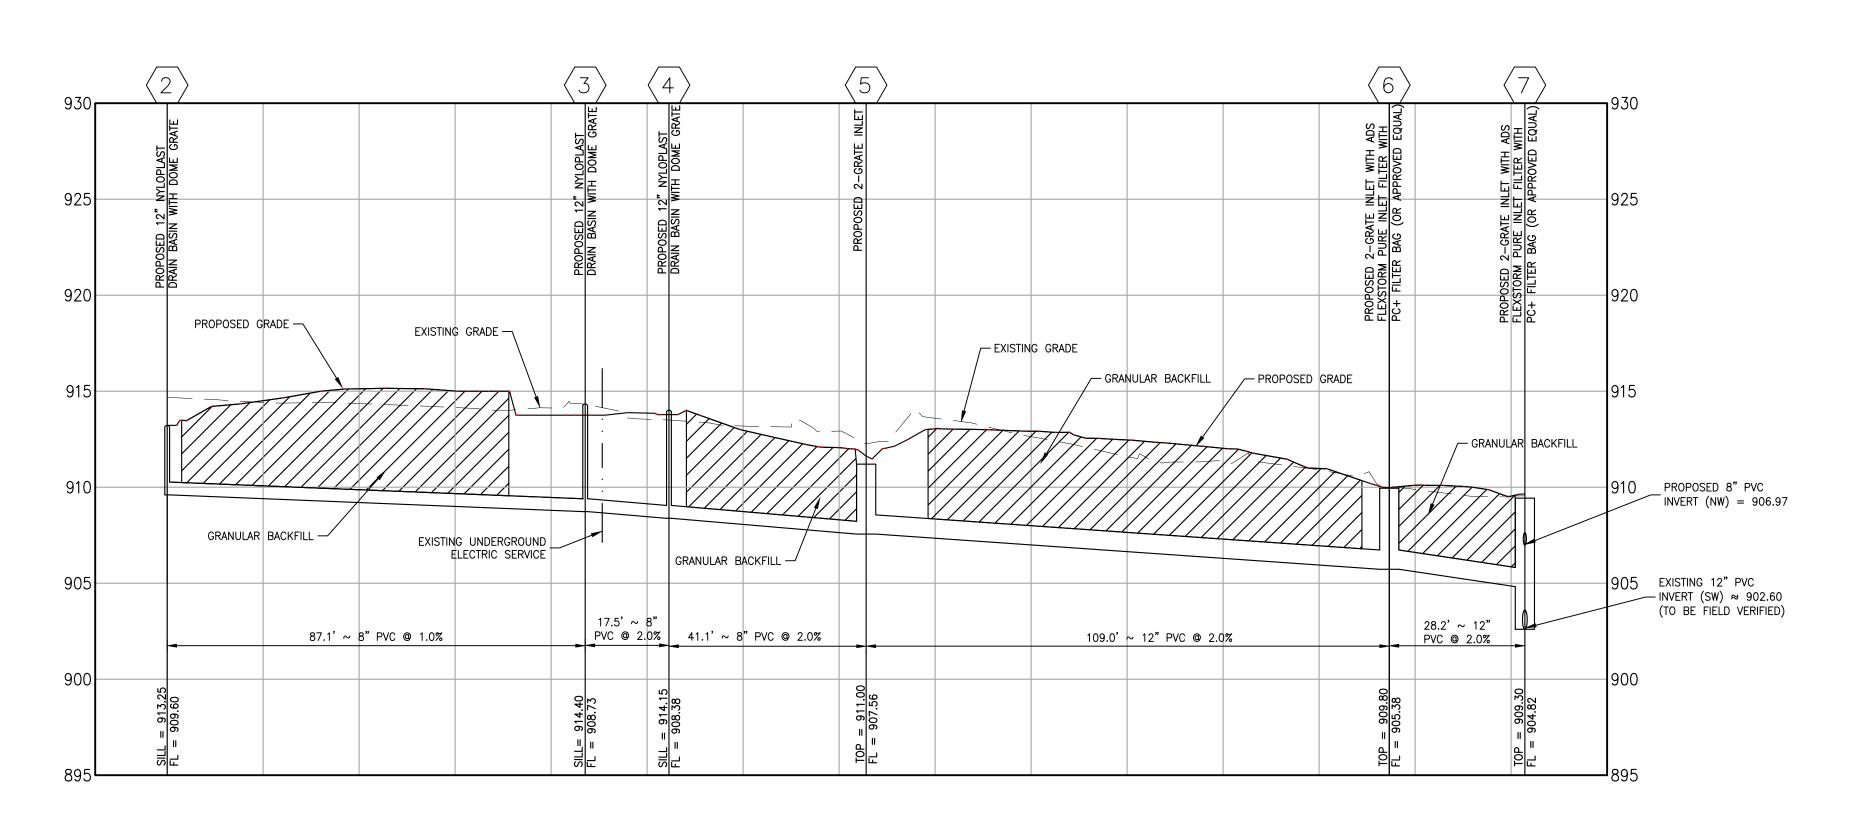
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LINE 2 STORM SEWER PROFILE

SCALE: 1"=20' HORIZ. 1"=5' VERT. REF. DWG. C6.0

3630 SOUTH GEYER ROAD, SUITE 100

ST. LOUIS, MO 63127

(314) 984-1000

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51 EAST SPRINGS DRIVE
MADISON, WI 53704

[SEWER PROFILES

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S. 18th Street
Set 200
2651
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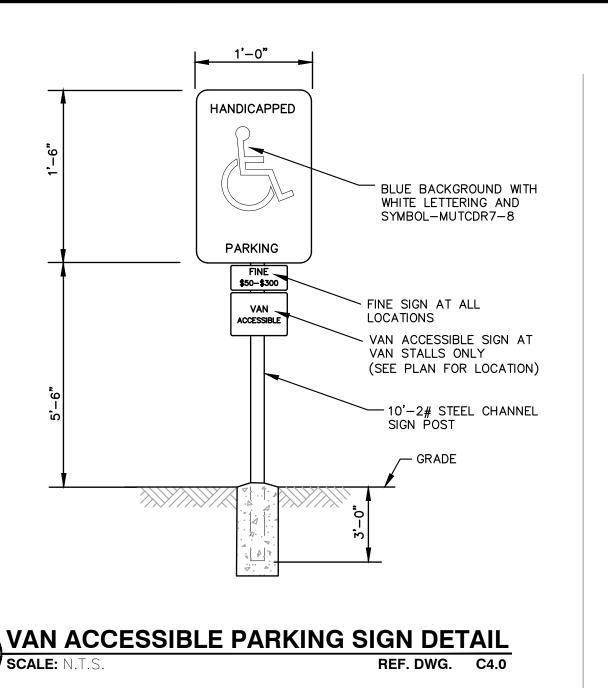
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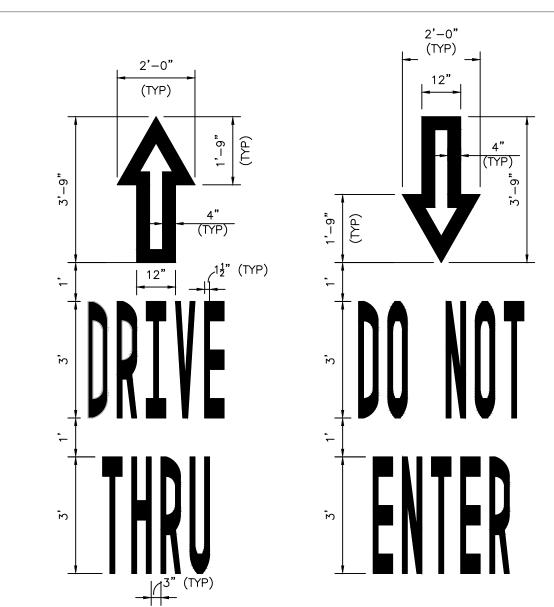
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Job Number 20-0003

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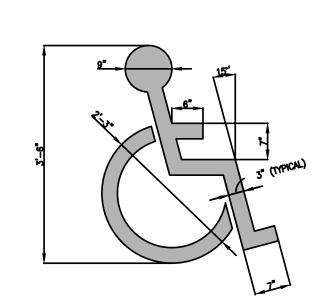


DRIVE THRU ARROW

DO NOT ENTER ARROW


<u>DETAIL NOTES:</u>
1. ARROWS SHALL BE PAINTED SOLID REFLECTIVE YELLOW OR PER LOCAL CODES.


\DRIVE-THRU/DO NOT ENTER DETAIL SCALE: N. REF. DWG. C4.0




DETAIL NOTES:
1. SYMBOL COLOR SHALL COMPLY WITH ALL LOCAL REGULATIONS.

ACCESSIBLE PARKING SYMBOL DETAIL SCALE: N.

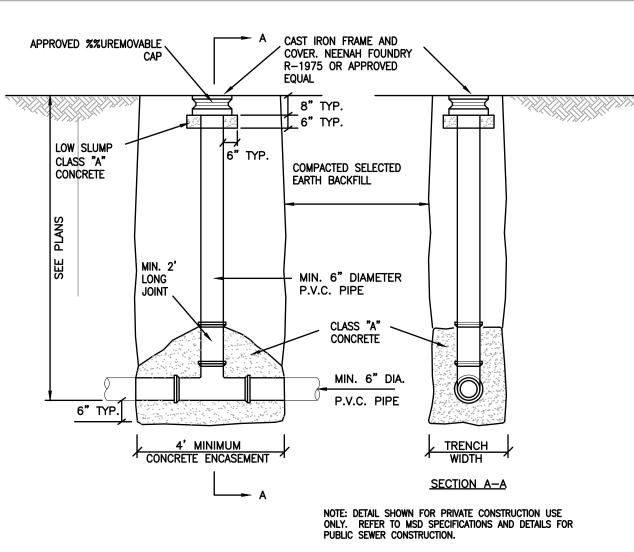

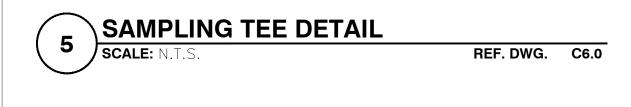

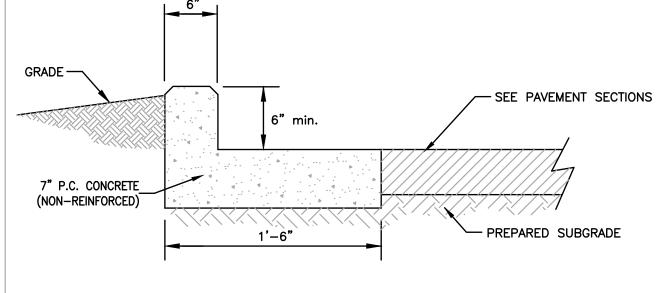



1.) ALL CONCRETE SHALL BE MIN. FC.=4,000 P.S.I. (UNLESS


OTHERWISE NOTED) 2.) ANY UNSUITABLE SOIL (AS DETERMINED BY SOILS ENGINEER) BELOW STRUCTURE SHALL BE REMOVED AND REPLACED WITH SELECT EARTHEN MATERIAL COMPACTED IN PLACE WITH VIBRATORY TAMPER. 3.) ALL EXPOSED CONCRETE EDGES TO HAVE 3/4" CHAMFER.

4.) DIMENSIONS SHOWN ARE TO FACE OF CURB.

CONCRETE CURB AND GUTTER DETAIL SCALE: N.T.S REF. DWG. C4.0

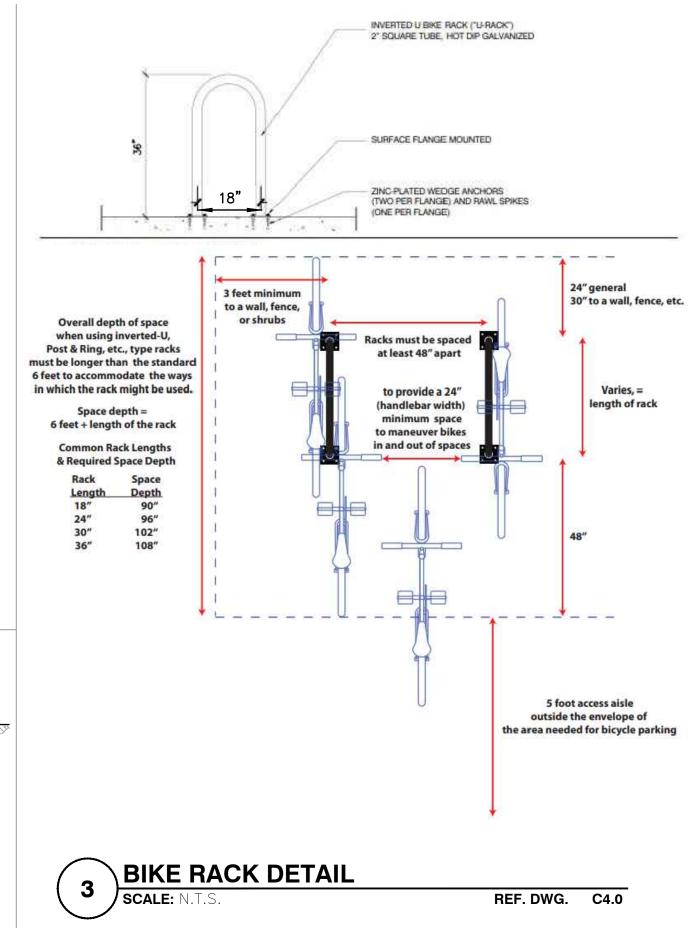


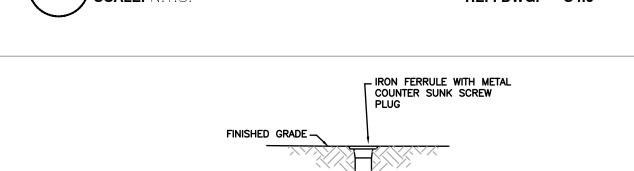

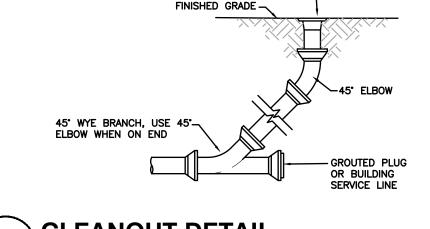

CLEANOUT DETAIL SCALE: N.


REF. DWG. C6.0

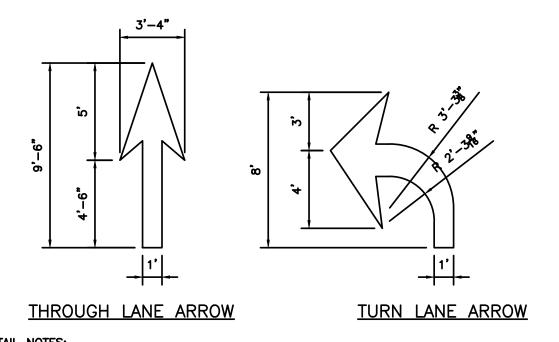

DETAIL NOTES:

1. RIGHT TURN ARROW TO BE THE REVERSE OF TURN LANE ARROW SHOWN ABOVE. ARROWS SHALL BE PAINTED REFLECTIVE WHITE. 3. ARROWS SHALL BE APPLIED PER CHAPTER 3B OF THE MUTCD, LATEST EDITION.

TRAFFIC FLOW ARROW DETAIL SCALE: N.T.S REF. DWG. C4.0

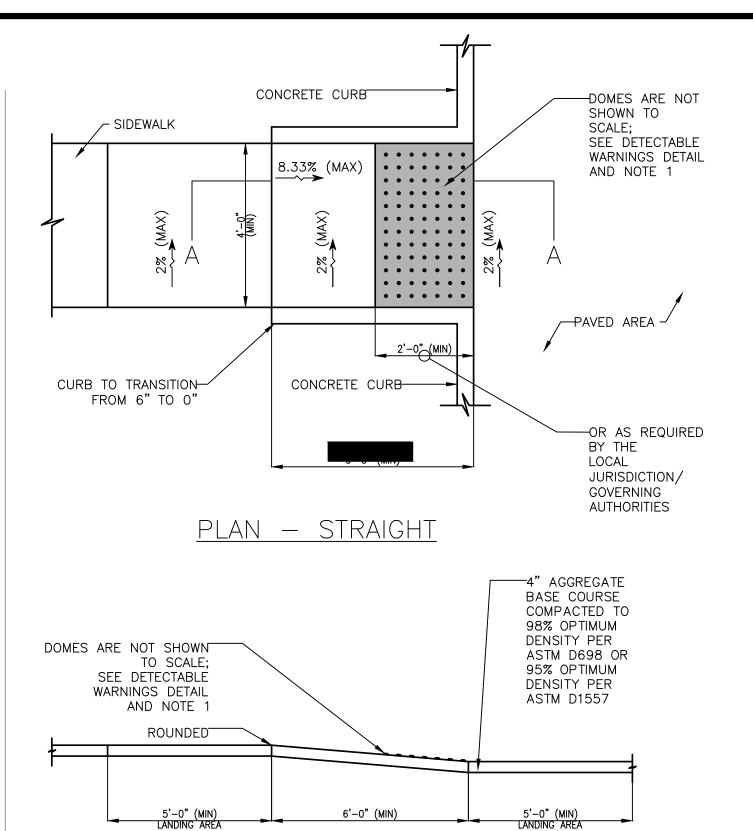



1. THE SURFACE OF RAMP SHALL HAVE DETECTABLE WARNINGS AS SHOWN. DETECTABLE WARNINGS SHALL CONSIST OF RAISED TRUNCATED DOMES. SEE DETECTABLE WARNINGS

DETAIL NOTE:

PREFABRICATED PANELS PER A.D.A.

ACCESSIBILITY GUIDELINES SECTION 4.29.2 & A4.29.2 SHALL BE USED.

DETECTABLE

WARNING DETAIL

SECTION A-A


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2. RAMP SIDE SLOPE VARIES UNIFORMLY FROM A MAXIMUM OF UP TO 10% AT CURB TO CONFORM WITH LONGITUDINAL SIDEWALK SLOPE ADJACENT TO TOP OF THE RAMP.

CONSTRUCT PER A.D.A. STANDARDS. 4. REFER TO PLANS FOR ADJACENT SLOPES.

ELEVATION

5. THE CROSS SLOPE OF THE RAMP SURFACE SHALL BE NO GREATER THAN 1:50.

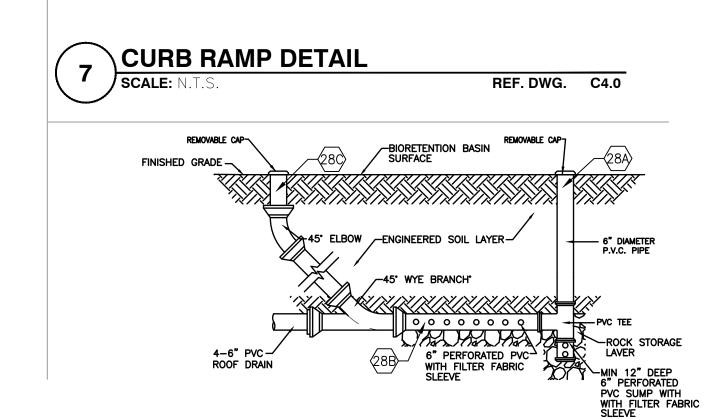


BIORETENTION CLEANOUT DETAIL SCALE: N. REF. DWG. C6.0 TTOC ST.

SHEET BAKE


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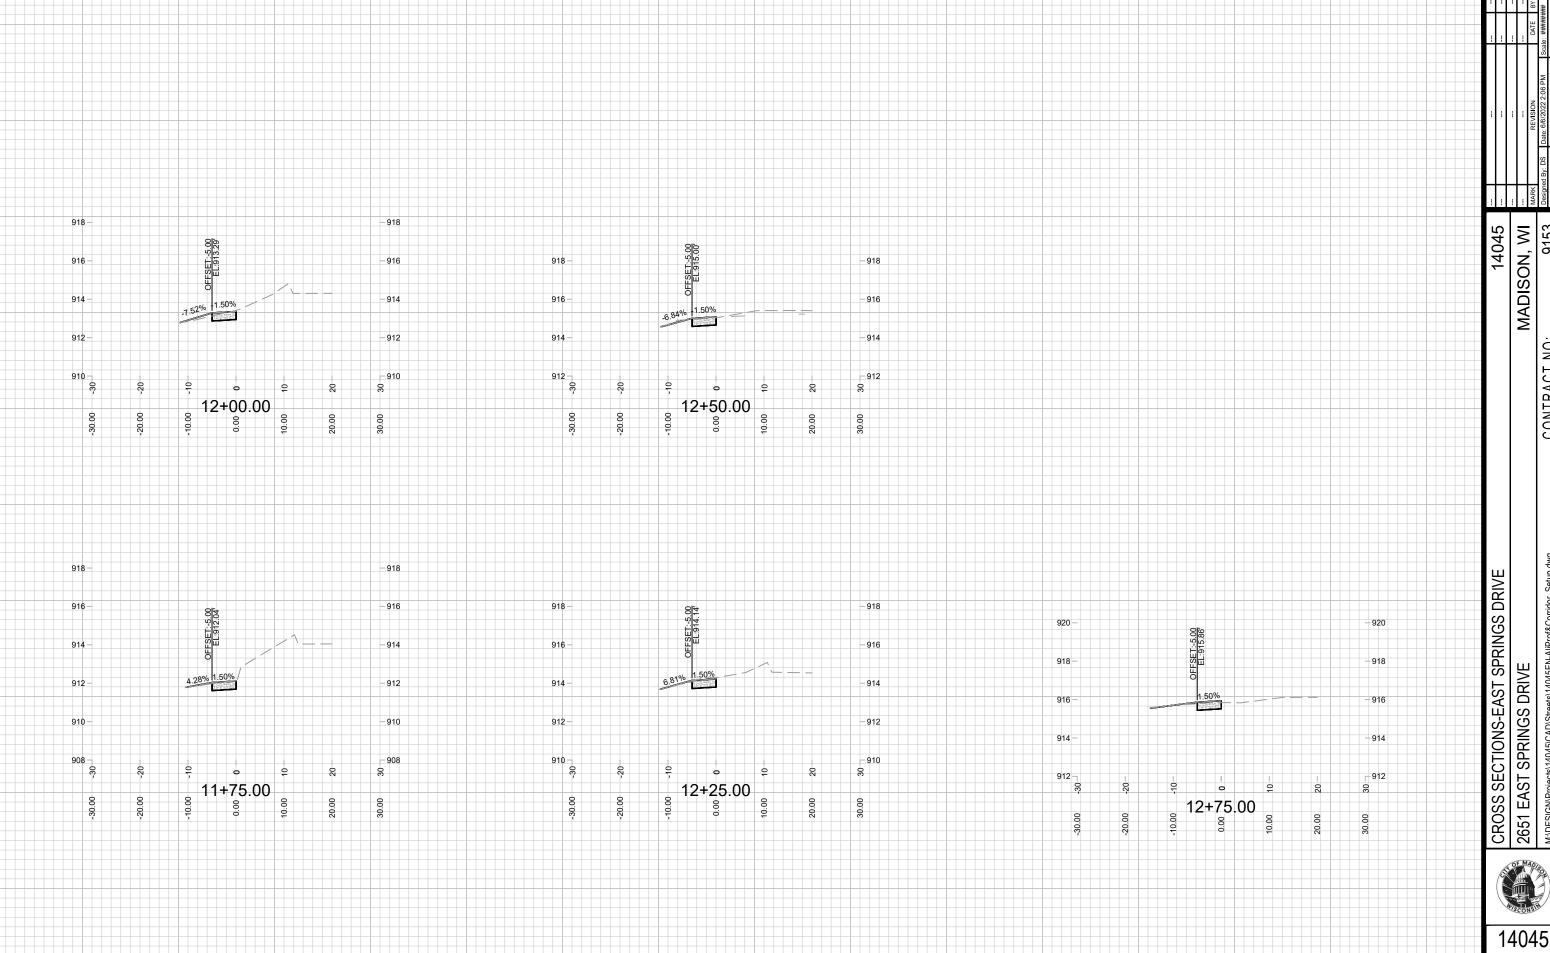
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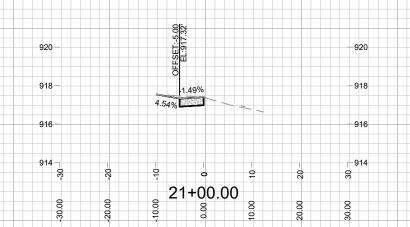



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MADISON, WI 9153 . 0 N CONTRACT 2651 EAST SPRINGS DRIVE



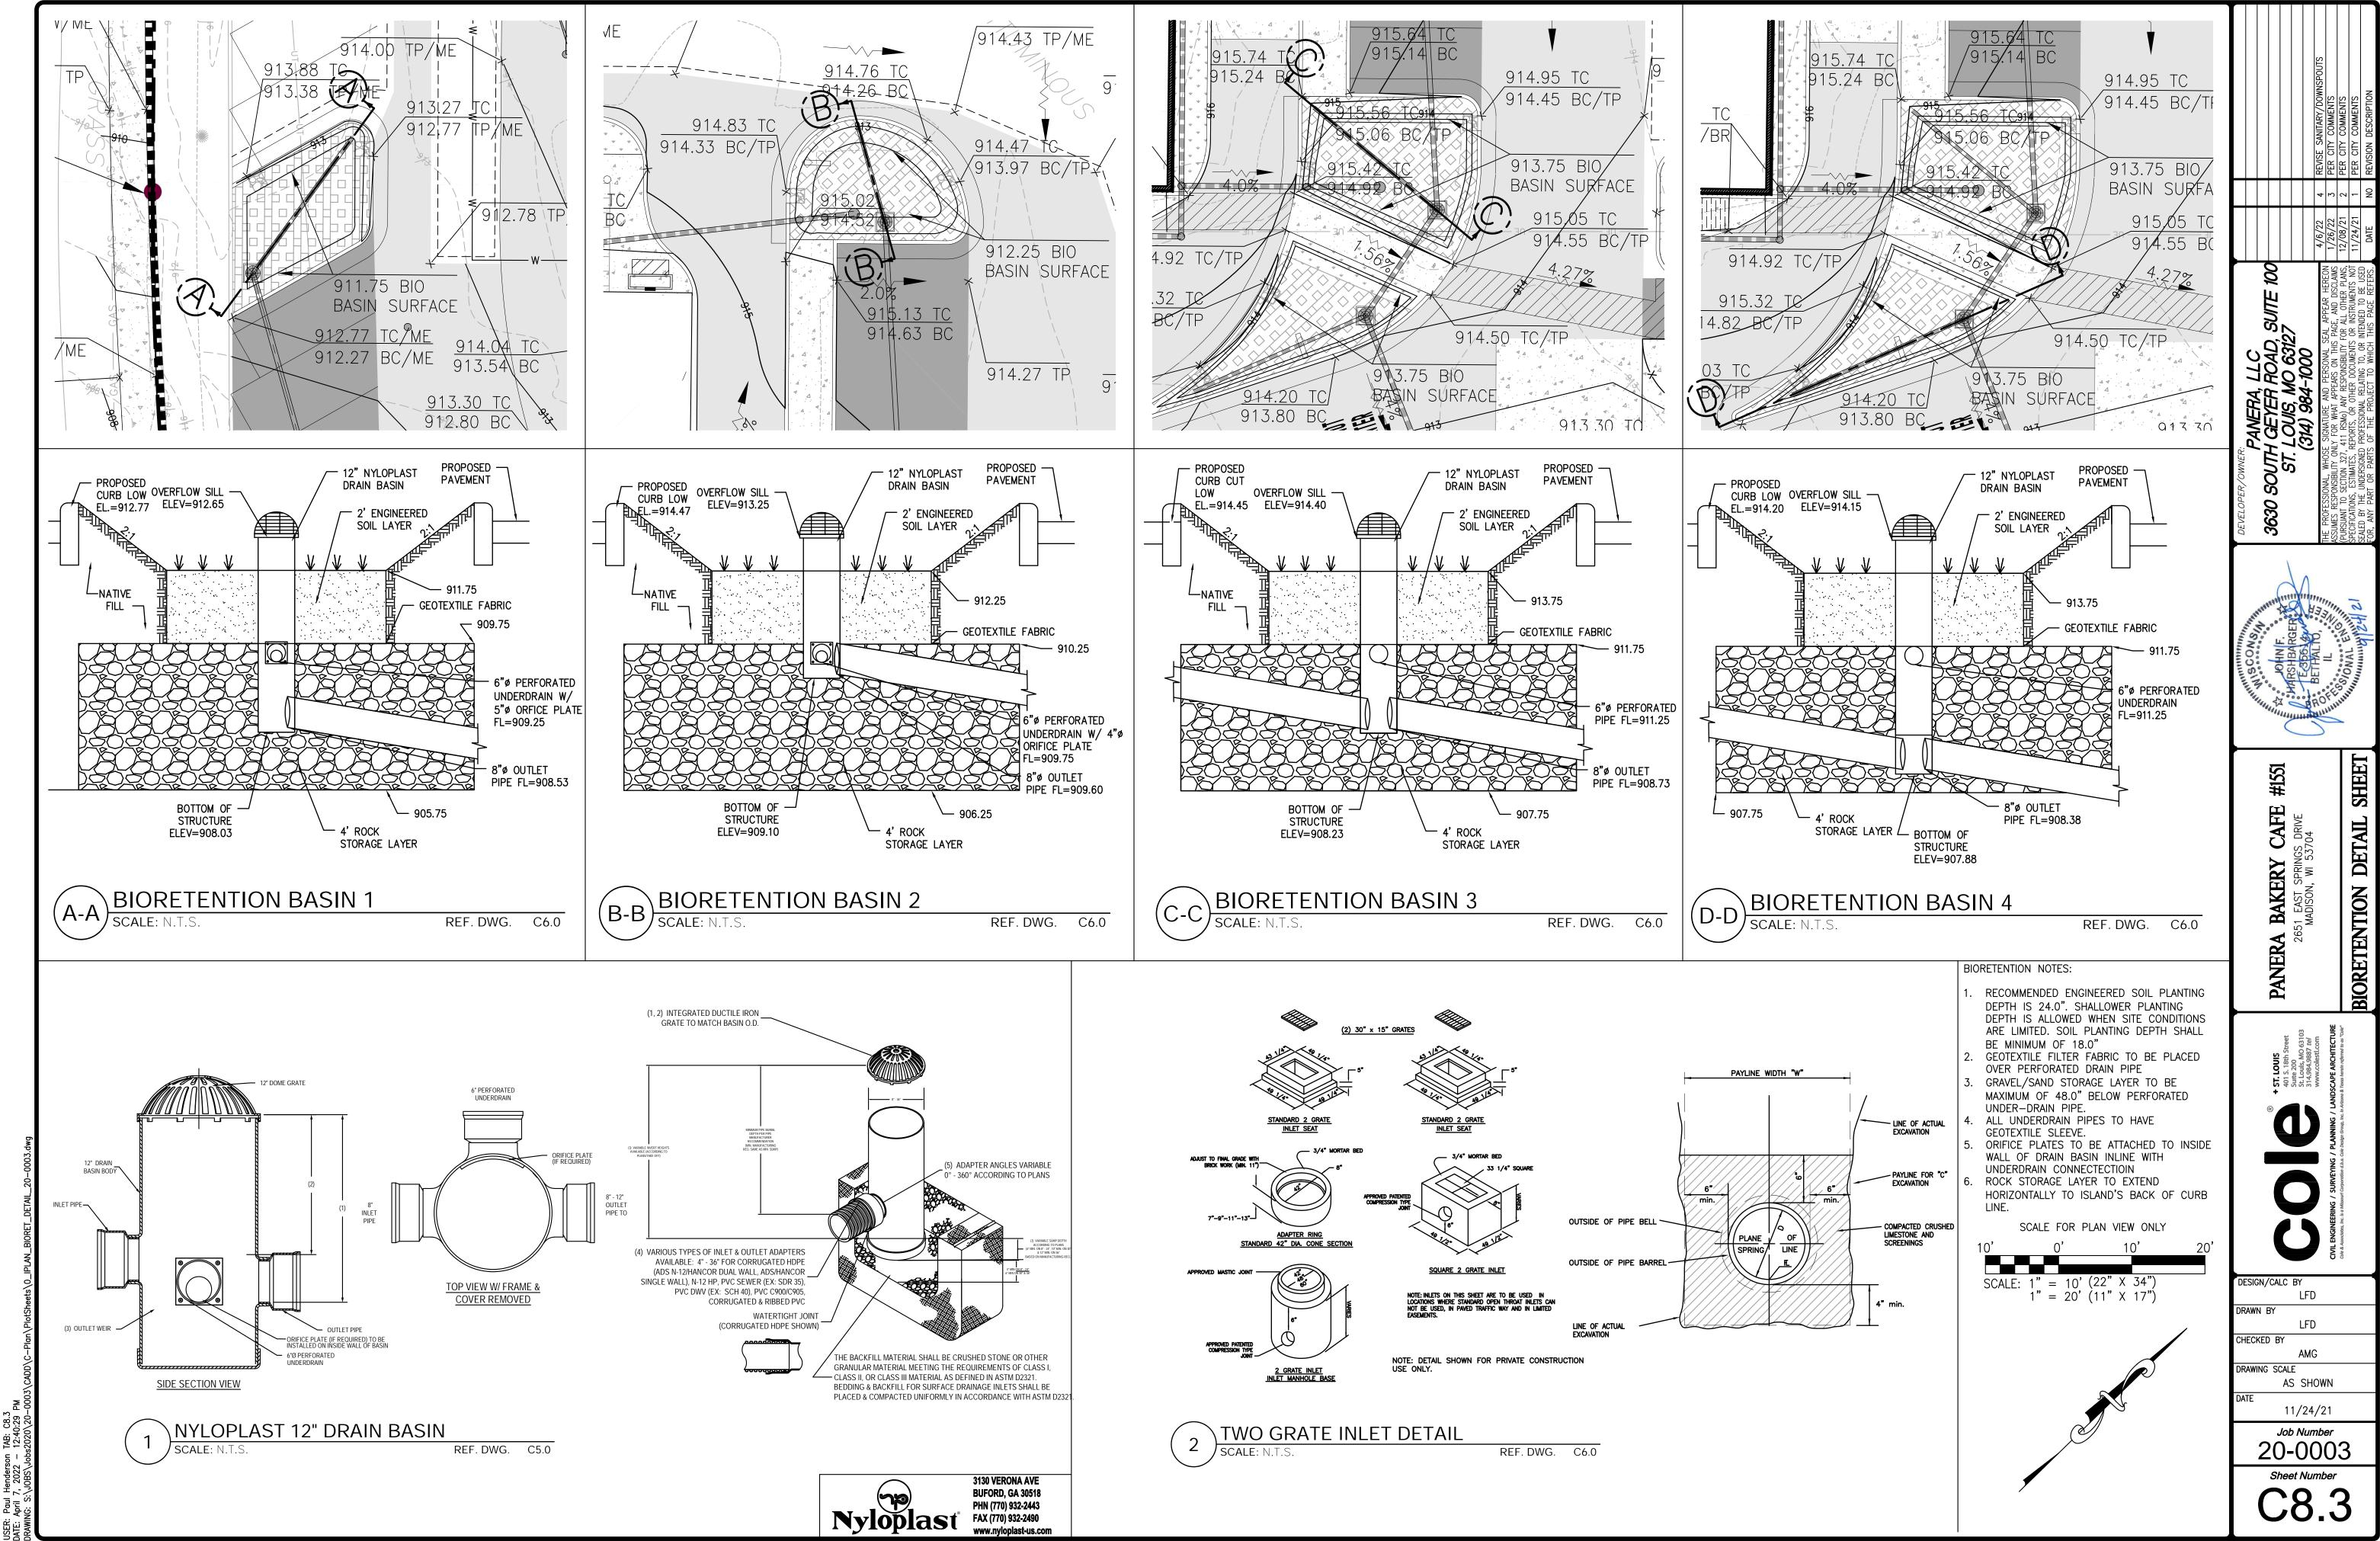

MADISON, WI 9153 14045 CONTRACT NO: CROSS SECTIONS-EAST WASHINGTON AVENUE 2651 EAST SPRINGS DRIVE

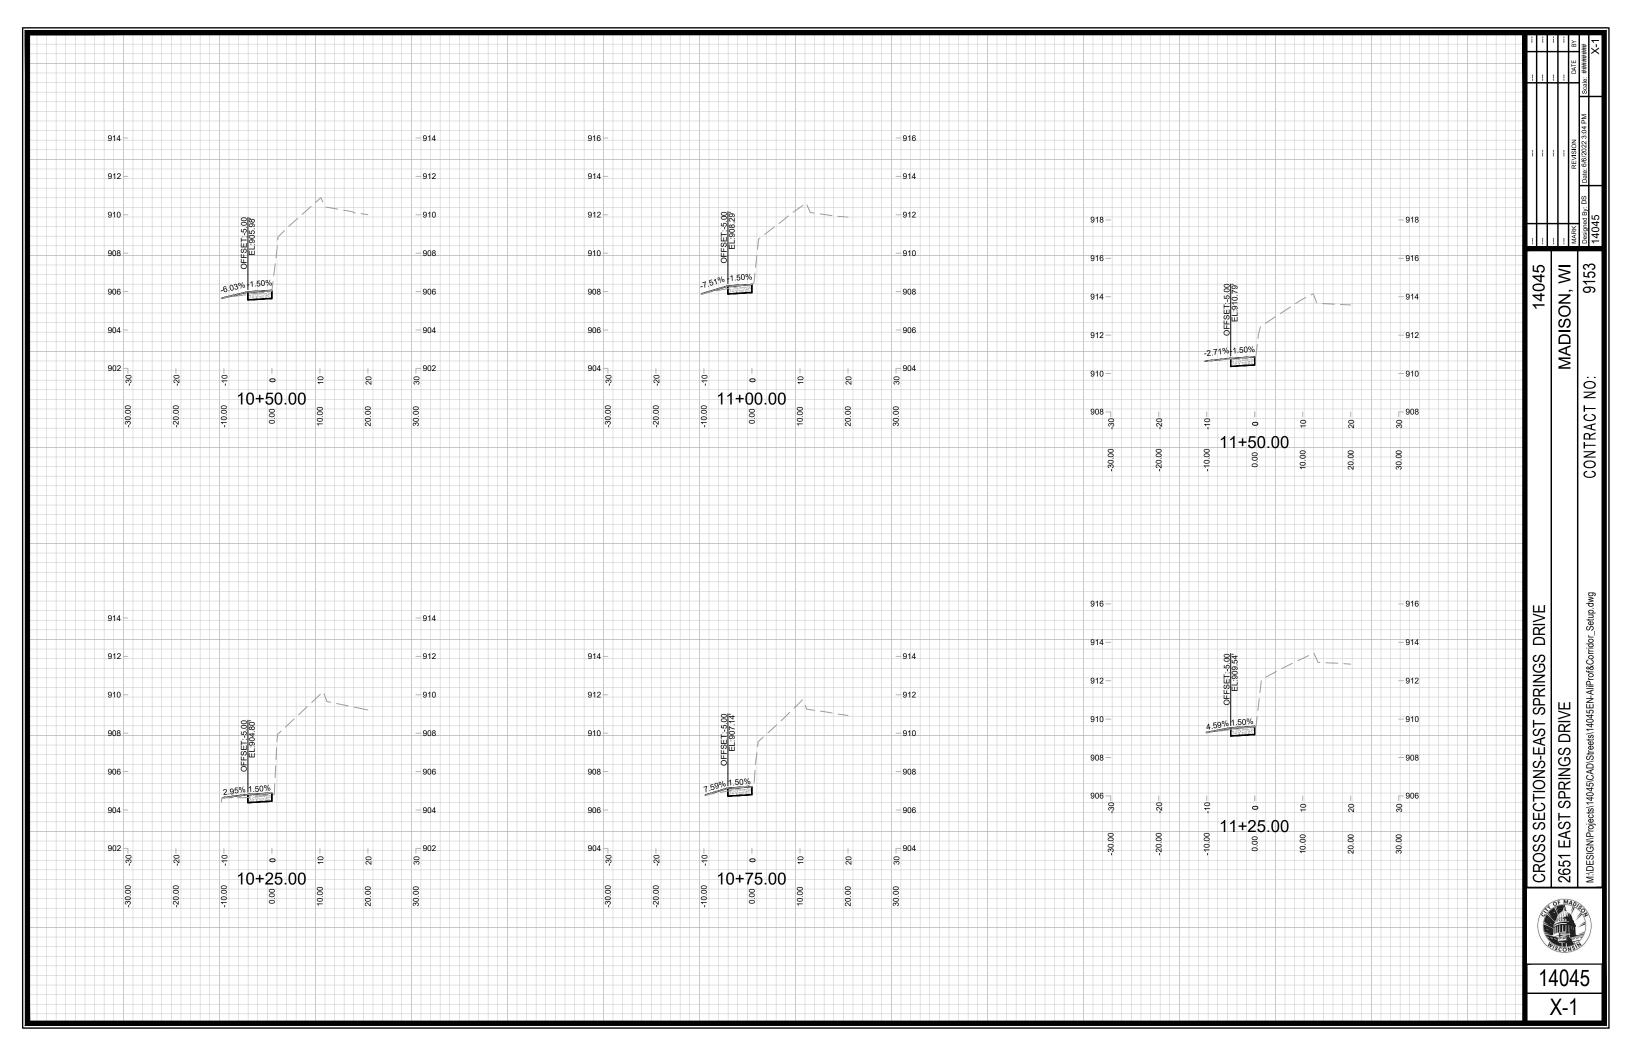

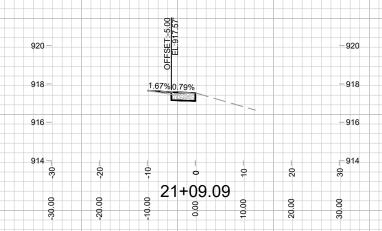14045

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